


## CONDITIONAL USE PERMIT DOCUMENTS FOR:

# NORTH CHATHAM VILLAGE

11500 US 15-501 N CHATHAM COUNTY, NC PIN: 9776-33-5210.000

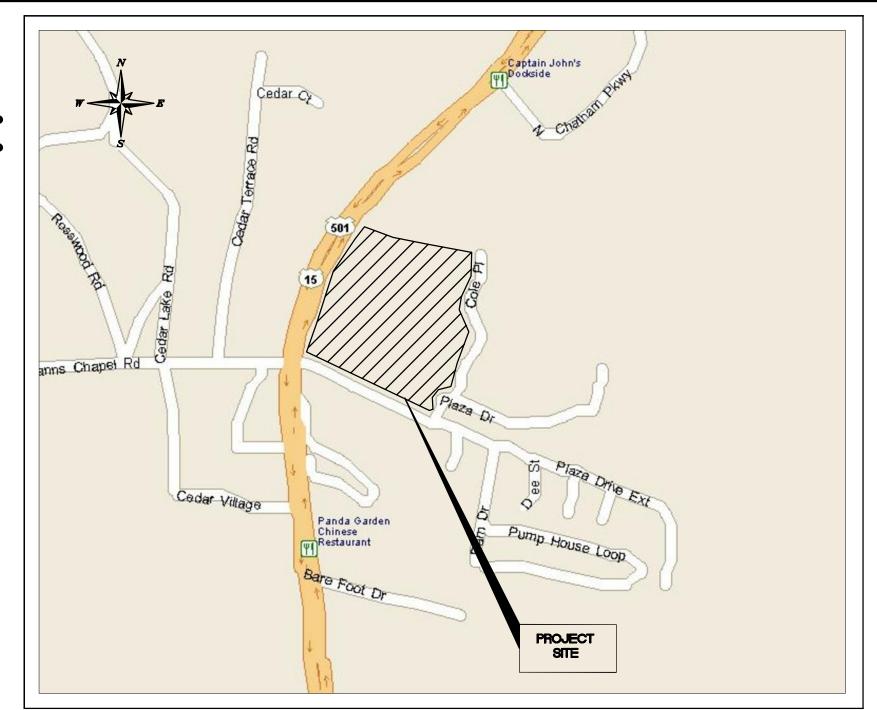

VICINITY MAP

#### SUMMARY INFORMATION

THE KEITH CORPORATION 5935 CARNEGIE BLVD., SUITE 200 CHARLOTTE, NC 28209 PHONE: (704)319-8170 ATTN: LÀURA MONDRICK

CIVIL ENGINEER:

KIMLEY-HORN AND ASSOCIATES, INC. 333 FAYETTEVILLE ST. SUITE 600 RALEIGH, NC 27601 PHONE: (919) 653-2927

ATTN.: CHRIS BOSTIC, P.E.

LANDSCAPE ARCHITECT

KIMLEY-HORN AND ASSOCIATES, INC. 333 FAYETTEVILLE ST. SUITE 600 RALEIGH, NC 27601 PHONE: (919) 653-2976

ARCHITECT:

CHARLOTTE, NC 28204 PHONE: (704) 370-6000 FAX: (704) 370-6006 ATTN: WYĆ CHILDREY

SABER ENGINEERING 2923 SOUTH TRYON STREET, SUITE 280 CHARLOTTE, NC 28203 PHONE: (704) 373-0068

ATTN: RICHARD M. MORRISON JR.

ATTN.: RÌCHÁRD BROWN, PLA

CHILDREY ROBINSION ASSOCIATES 1212 KENILWORTH AVENUE

JAMES MAUNEY & ASSOCIATES, P.A. PROFESSIONAL LAND SURVEYORS 6405 WILKINSON BLVD., SUITE 11

BELMONT, NC 28012 PHONE: (704) 829-9623 FAX: (704) 829-9625 ATTN: JAMES P. CAMERON

PRELIMINARY PLANS NOT FOR CONSTRUCTION


Sheet List Table			
Sheet Number	Sheet Title		
C000	COVER SHEET		
C100	EXISTING CONDITIONS		
C200	DEMOLITION PLAN		
C300	SITE PLAN		
C400	GRADING AND DRAINAGE PLAN		
C500	UTILITY PLAN		
L-1.0	LANDSCAPE PLAN		
A-201	ELEVATIONS		
A-201.1	ELEVATIONS		
A-202	ELEVATIONS		
E-1	PLAN AND FIXTURE LAYOUT		
T1.0	COVER		
R1.1	OCCUPANCY PLAN		
R1.3	SEATING PLAN		
A2.0	ELEVATIONS		
A2.1	ELEVATIONS		
REVISIONS			

NO. DATE DESCRIPTION

NC CERT. OF AUTH: F-0102

This document, together with the concepts and designs presented herein, as an instrument of services, is intended only for the specific purpose and client for which it was prepared. Reuse of and improper reliance on this document without written authorization and adaptation by Kimley-Horn and Associates, Inc. shall be without liability to Kimley-Horn and Associates, Inc. Copyright Kimley-Horn and Associates, Inc., 2014 DATE: KHA PROJECT NO: JULY 3, 2014 012700000

Kimley» Horn 333 FAYETTEVILLE STREET, SUITE 600, RALEIGH, NORTH CAROLINA 27601 PHONE: (919) 835-1494

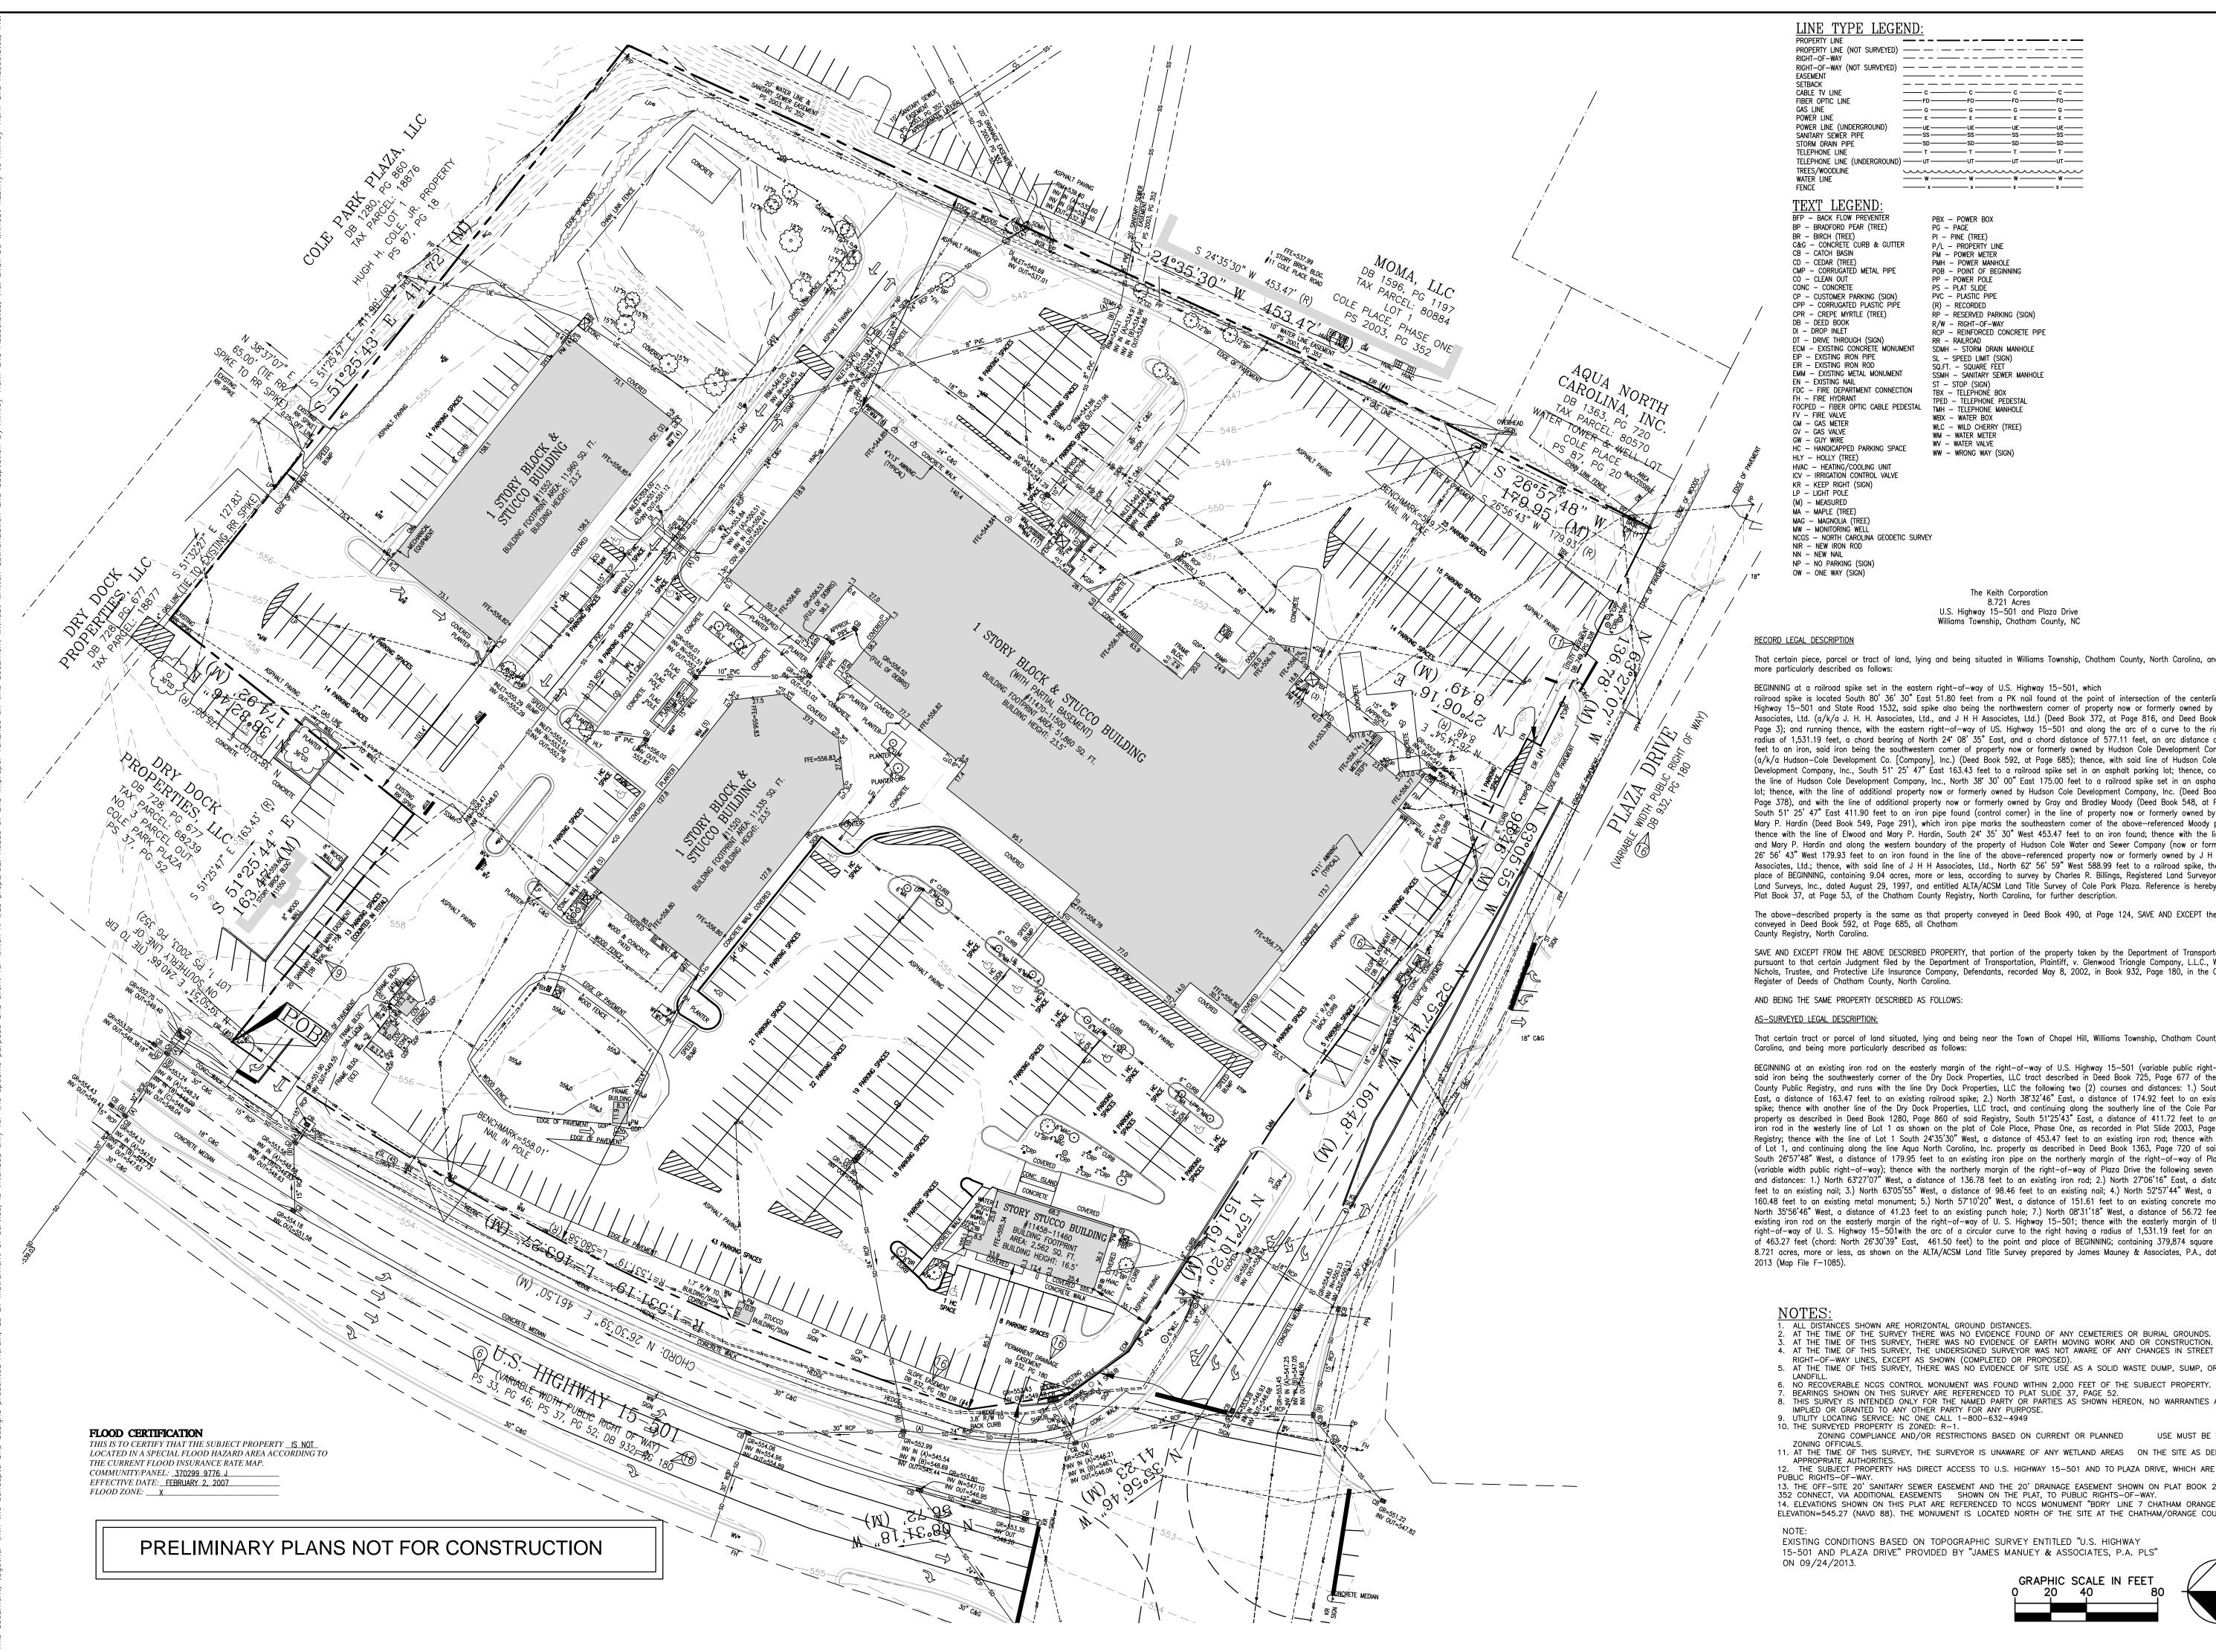



U.S. Highway 15-501 and Plaza Drive Williams Township, Chatham County, NC

That certain piece, parcel or tract of land, lying and being situated in Williams Township, Chatham County, North Carolina, and being

BEGINNING at a railroad spike set in the eastern right-of-way of U.S. Highway 15-501, which

railroad spike is located South 80' 36' 30" East 51.80 feet from a PK nail found at the point of intersection of the centerline of U.S. Highway 15-501 and State Road 1532, said spike also being the northwestern corner of property now or formerly owned by J H H Associates, Ltd. (a/k/a J. H. H. Associates, Ltd., and J H H Associates, Ltd.) (Deed Book 372, at Page 816, and Deed Book 384, at Page 3); and running thence, with the eastern right—of—way of US. Highway 15—501 and along the arc of a curve to the right, having a radius of 1,531.19 feet, a chord bearing of North 24° 08' 35" East, and a chord distance of 577.11 feet, an arc distance of 580.58 feet to an iron, said iron being the southwestern comer of property now or formerly owned by Hudson Cole Development Company, Inc. (a/k/a Hudson-Cole Development Co. [Company], Inc.) (Deed Book 592, at Page 685); thence, with said line of Hudson Cole Development Company, Inc., South 51° 25' 47" East 163.43 feet to a railroad spike set in an asphalt parking lot; thence, continuing with the line of Hudson Cole Development Company, Inc., North 38° 30' 00" East 175.00 feet to a railroad spike set in an asphalt parking lot; thence, with the line of additional property now or formerly owned by Hudson Cole Development Company, Inc. (Deed Book 473, at Page 378), and with the line of additional property now or formerly owned by Gray and Bradley Moody (Deed Book 548, at Page 843), South 51° 25' 47" East 411.90 feet to an iron pipe found (control comer) in the line of property now or formerly owned by Elwood and Mary P. Hardin (Deed Book 549, Page 291), which iron pipe marks the southeastern comer of the above—referenced Moody property; thence with the line of Elwood and Mary P. Hardin, South 24° 35' 30" West 453.47 feet to an iron found; thence with the line of Elwood and Mary P. Hardin and along the western boundary of the property of Hudson Cole Water and Sewer Company (now or formerly) South 26° 56′ 43″ West 179.93 feet to an iron found in the line of the above—referenced property now or formerly owned by J H H Associates, Ltd.; thence, with said line of J H H Associates, Ltd., North 62° 56′ 59" West 588.99 feet to a railroad spike, the point place of BEGINNING, containing 9.04 acres, more or less, according to survey by Charles R. Billings, Registered Land Surveyor, Freehold Land Surveys, Inc., dated August 29, 1997, and entitled ALTA/ACSM Land Title Survey of Cole Park Plaza. Reference is hereby made to Plat Book 37, at Page 53, of the Chatham County Registry, North Carolina, for further description.

The above-described property is the same as that property conveyed in Deed Book 490, at Page 124, SAVE AND EXCEPT the property conveyed in Deed Book 592, at Page 685, all Chatham

SAVE AND EXCEPT FROM THE ABOVE DESCRIBED PROPERTY, that portion of the property taken by the Department of Transportation pursuant to that certain Judgment filed by the Department of Transportation, Plaintiff, v. Glenwood Triangle Company, L.L.C., W. Alan Nichols, Trustee, and Protective Life Insurance Company, Defendants, recorded May 8, 2002, in Book 932, Page 180, in the Office of the Register of Deeds of Chatham County, North Carolina.

AND BEING THE SAME PROPERTY DESCRIBED AS FOLLOWS:

That certain tract or parcel of land situated, lying and being near the Town of Chapel Hill, Williams Township, Chatham County, North


BEGINNING at an existing iron rod on the easterly margin of the right-of-way of U.S. Highway 15-501 (variable public right-of-way), said iron being the southwesterly corner of the Dry Dock Properties, LLC tract described in Deed Book 725, Page 677 of the Chatham County Public Registry, and runs with the line Dry Dock Properties, LLC the following two (2) courses and distances: 1.) South 51°25'44" East, a distance of 163.47 feet to an existing railroad spike; 2.) North 38°32′46″ East, a distance of 174.92 feet to an existing railroad spike; thence with another line of the Dry Dock Properties, LLC tract, and continuing along the southerly line of the Cole Park Plaza, LLC property as described in Deed Book 1280, Page 860 of said Registry, South 51°25'43" East, a distance of 411.72 feet to an existing iron rod in the westerly line of Lot 1 as shown on the plat of Cole Place, Phase One, as recorded in Plat Slide 2003, Page 352 of said Registry; thence with the line of Lot 1 South 24°35'30" West, a distance of 453.47 feet to an existing iron rod; thence with another line of Lot 1, and continuing along the line Aqua North Carolina, Inc. property as described in Deed Book 1363, Page 720 of said Registry, South 26'57'48" West, a distance of 179.95 feet to an existing iron pipe on the northerly margin of the right-of-way of Plaza Drive (variable width public right-of-way); thence with the northerly margin of the right-of-way of Plaza Drive the following seven (7) courses and distances: 1.) North 63°27'07" West, a distance of 136.78 feet to an existing iron rod; 2.) North 27°06'16" East, a distance of 8.49 feet to an existing nail; 3.) North 63°05'55" West, a distance of 98.46 feet to an existing nail; 4.) North 52°57'44" West, a distance of 160.48 feet to an existing metal monument; 5.) North 57'10'20" West, a distance of 151.61 feet to an existing concrete monument; 6.) North 35°56′46″ West, a distance of 41.23 feet to an existing punch hole; 7.) North 08°31′18″ West, a distance of 56.72 feet to an existing iron rod on the easterly margin of the right-of-way of U. S. Highway 15-501; thence with the easterly margin of the right-of-way of U. S. Highway 15-501with the arc of a circular curve to the right having a radius of 1,531.19 feet for an arc distance of 463.27 feet (chord: North 26'30'39" East, 461.50 feet) to the point and place of BEGINNING; containing 379,874 square feet or 8.721 acres, more or less, as shown on the ALTA/ACSM Land Title Survey prepared by James Mauney & Associates, P.A., dated July 25,


- ALL DISTANCES SHOWN ARE HORIZONTAL GROUND DISTANCES.

  AT THE TIME OF THE SURVEY THERE WAS NO EVIDENCE FOUND OF ANY CEMETERIES OR BURIAL GROUNDS. AT THE TIME OF THIS SURVEY, THERE WAS NO EVIDENCE OF EARTH MOVING WORK AND OR CONSTRUCTION.
- RIGHT-OF-WAY LINES, EXCEPT AS SHOWN (COMPLETED OR PROPOSED) 5. AT THE TIME OF THIS SURVEY, THERE WAS NO EVIDENCE OF SITE USE AS A SOLID WASTE DUMP, SUMP, OR SANITARY
- 6. NO RECOVERABLE NCGS CONTROL MONUMENT WAS FOUND WITHIN 2,000 FEET OF THE SUBJECT PROPERTY.
  7. BEARINGS SHOWN ON THIS SURVEY ARE REFERENCED TO PLAT SLIDE 37, PAGE 52.
- THIS SURVEY IS INTENDED ONLY FOR THE NAMED PARTY OR PARTIES AS SHOWN HEREON, NO WARRANTIES ARE HEREBY IMPLIED OR GRANTED TO ANY OTHER PARTY FOR ANY PURPOSE.
- ZONING COMPLIANCE AND/OR RESTRICTIONS BASED ON CURRENT OR PLANNED ZONING OFFICIALS.


  11. AT THE TIME OF THIS SURVEY, THE SURVEYOR IS UNAWARE OF ANY WETLAND AREAS ON THE SITE AS DELINEATED BY THE SUBJECT PROPERTY HAS DIRECT ACCESS TO U.S. HIGHWAY 15-501 AND TO PLAZA DRIVE, WHICH ARE DEDICATED,

13. THE OFF-SITE 20' SANITARY SEWER EASEMENT AND THE 20' DRAINAGE EASEMENT SHOWN ON PLAT BOOK 2003, PAGE 352 CONNECT, VIA ADDITIONAL EASEMENTS SHOWN ON THE PLAT, TO PUBLIC RIGHTS-OF-WAY. 14. ELEVATIONS SHOWN ON THIS PLAT ARE REFERENCED TO NCGS MONUMENT "BDRY LINE 7 CHATHAM ORANGE CO", ELEVATION=545.27 (NAVD 88). THE MONUMENT IS LOCATED NORTH OF THE SITE AT THE CHATHAM/ORANGE COUNTY LINE

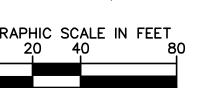

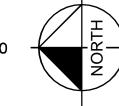

SHEET NUMBER C100

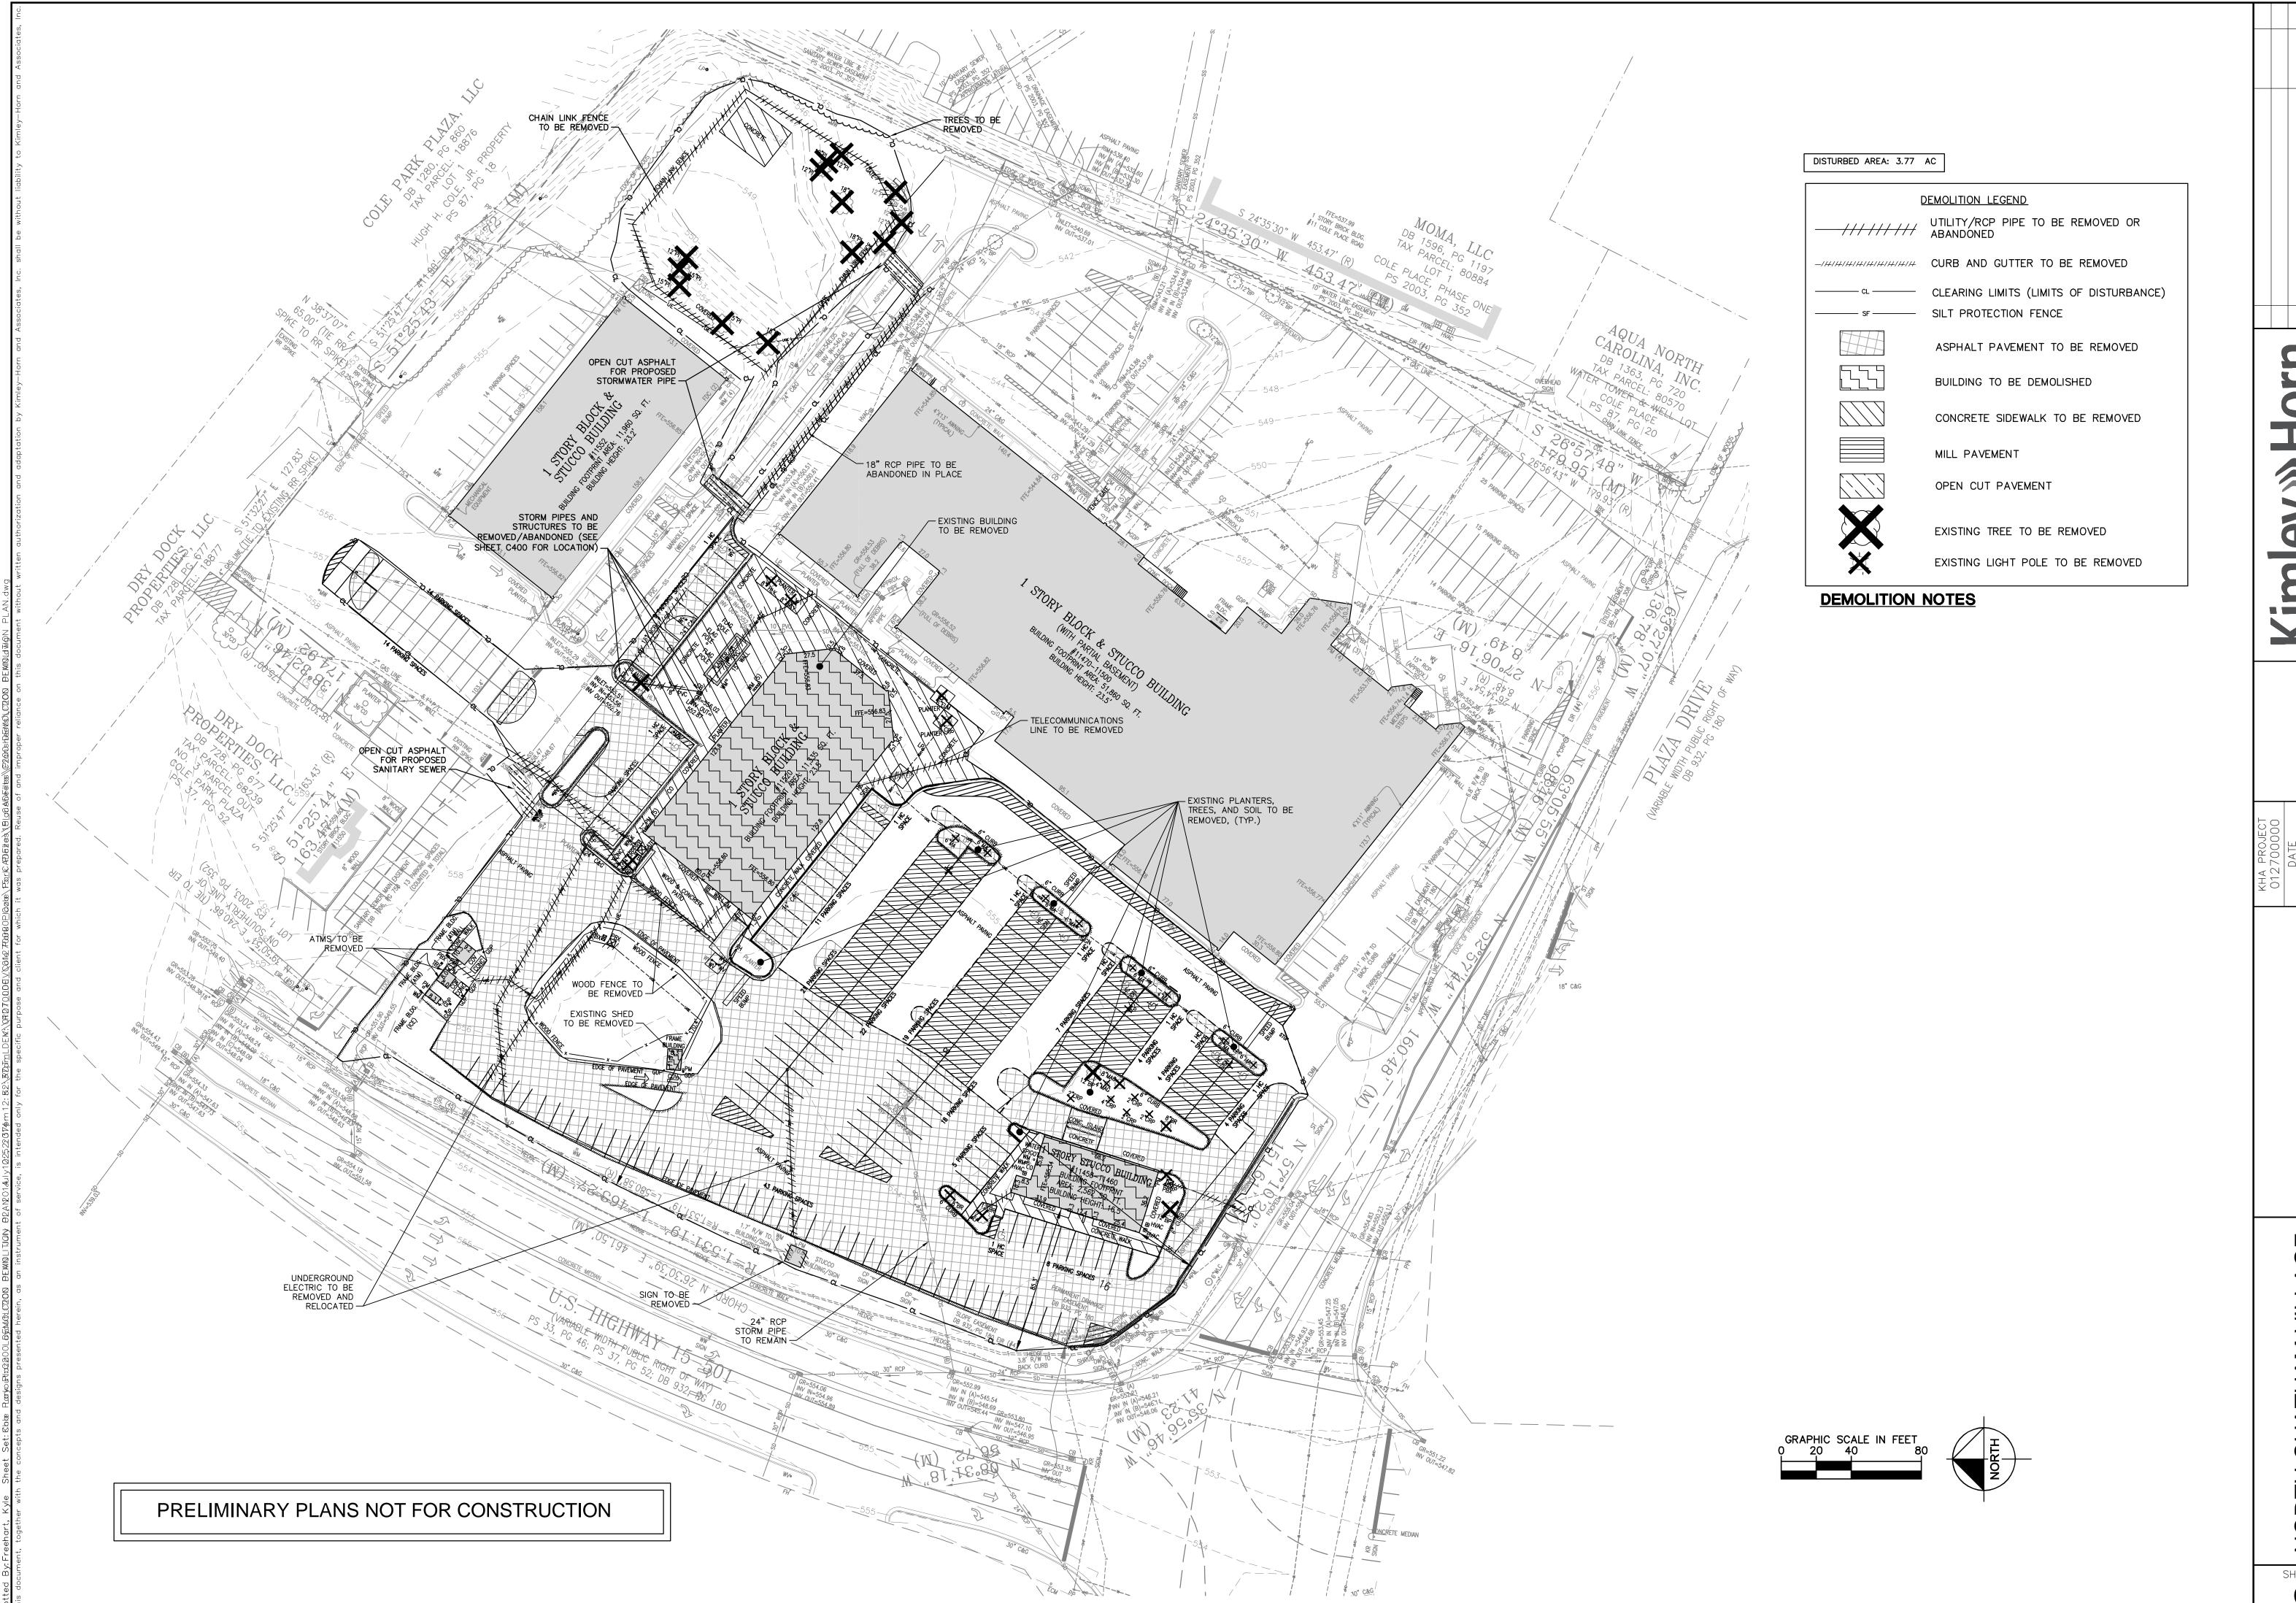

KIMLEY-HORN AND ASSOCIATES, INC.

MILLE STREET, SUITE 600, RALEIGH, NC 27601

919-835-1494 FAX: 919-653-5847

WWW.KIMLEY-HORN.COM


CALE AS SHOWN
ESIGNED BY KJF
IRAWN BY KJF
SHECKED BY COB


DEMOLITION PLAN


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THE KEITH CORP


SHEET NUMBER



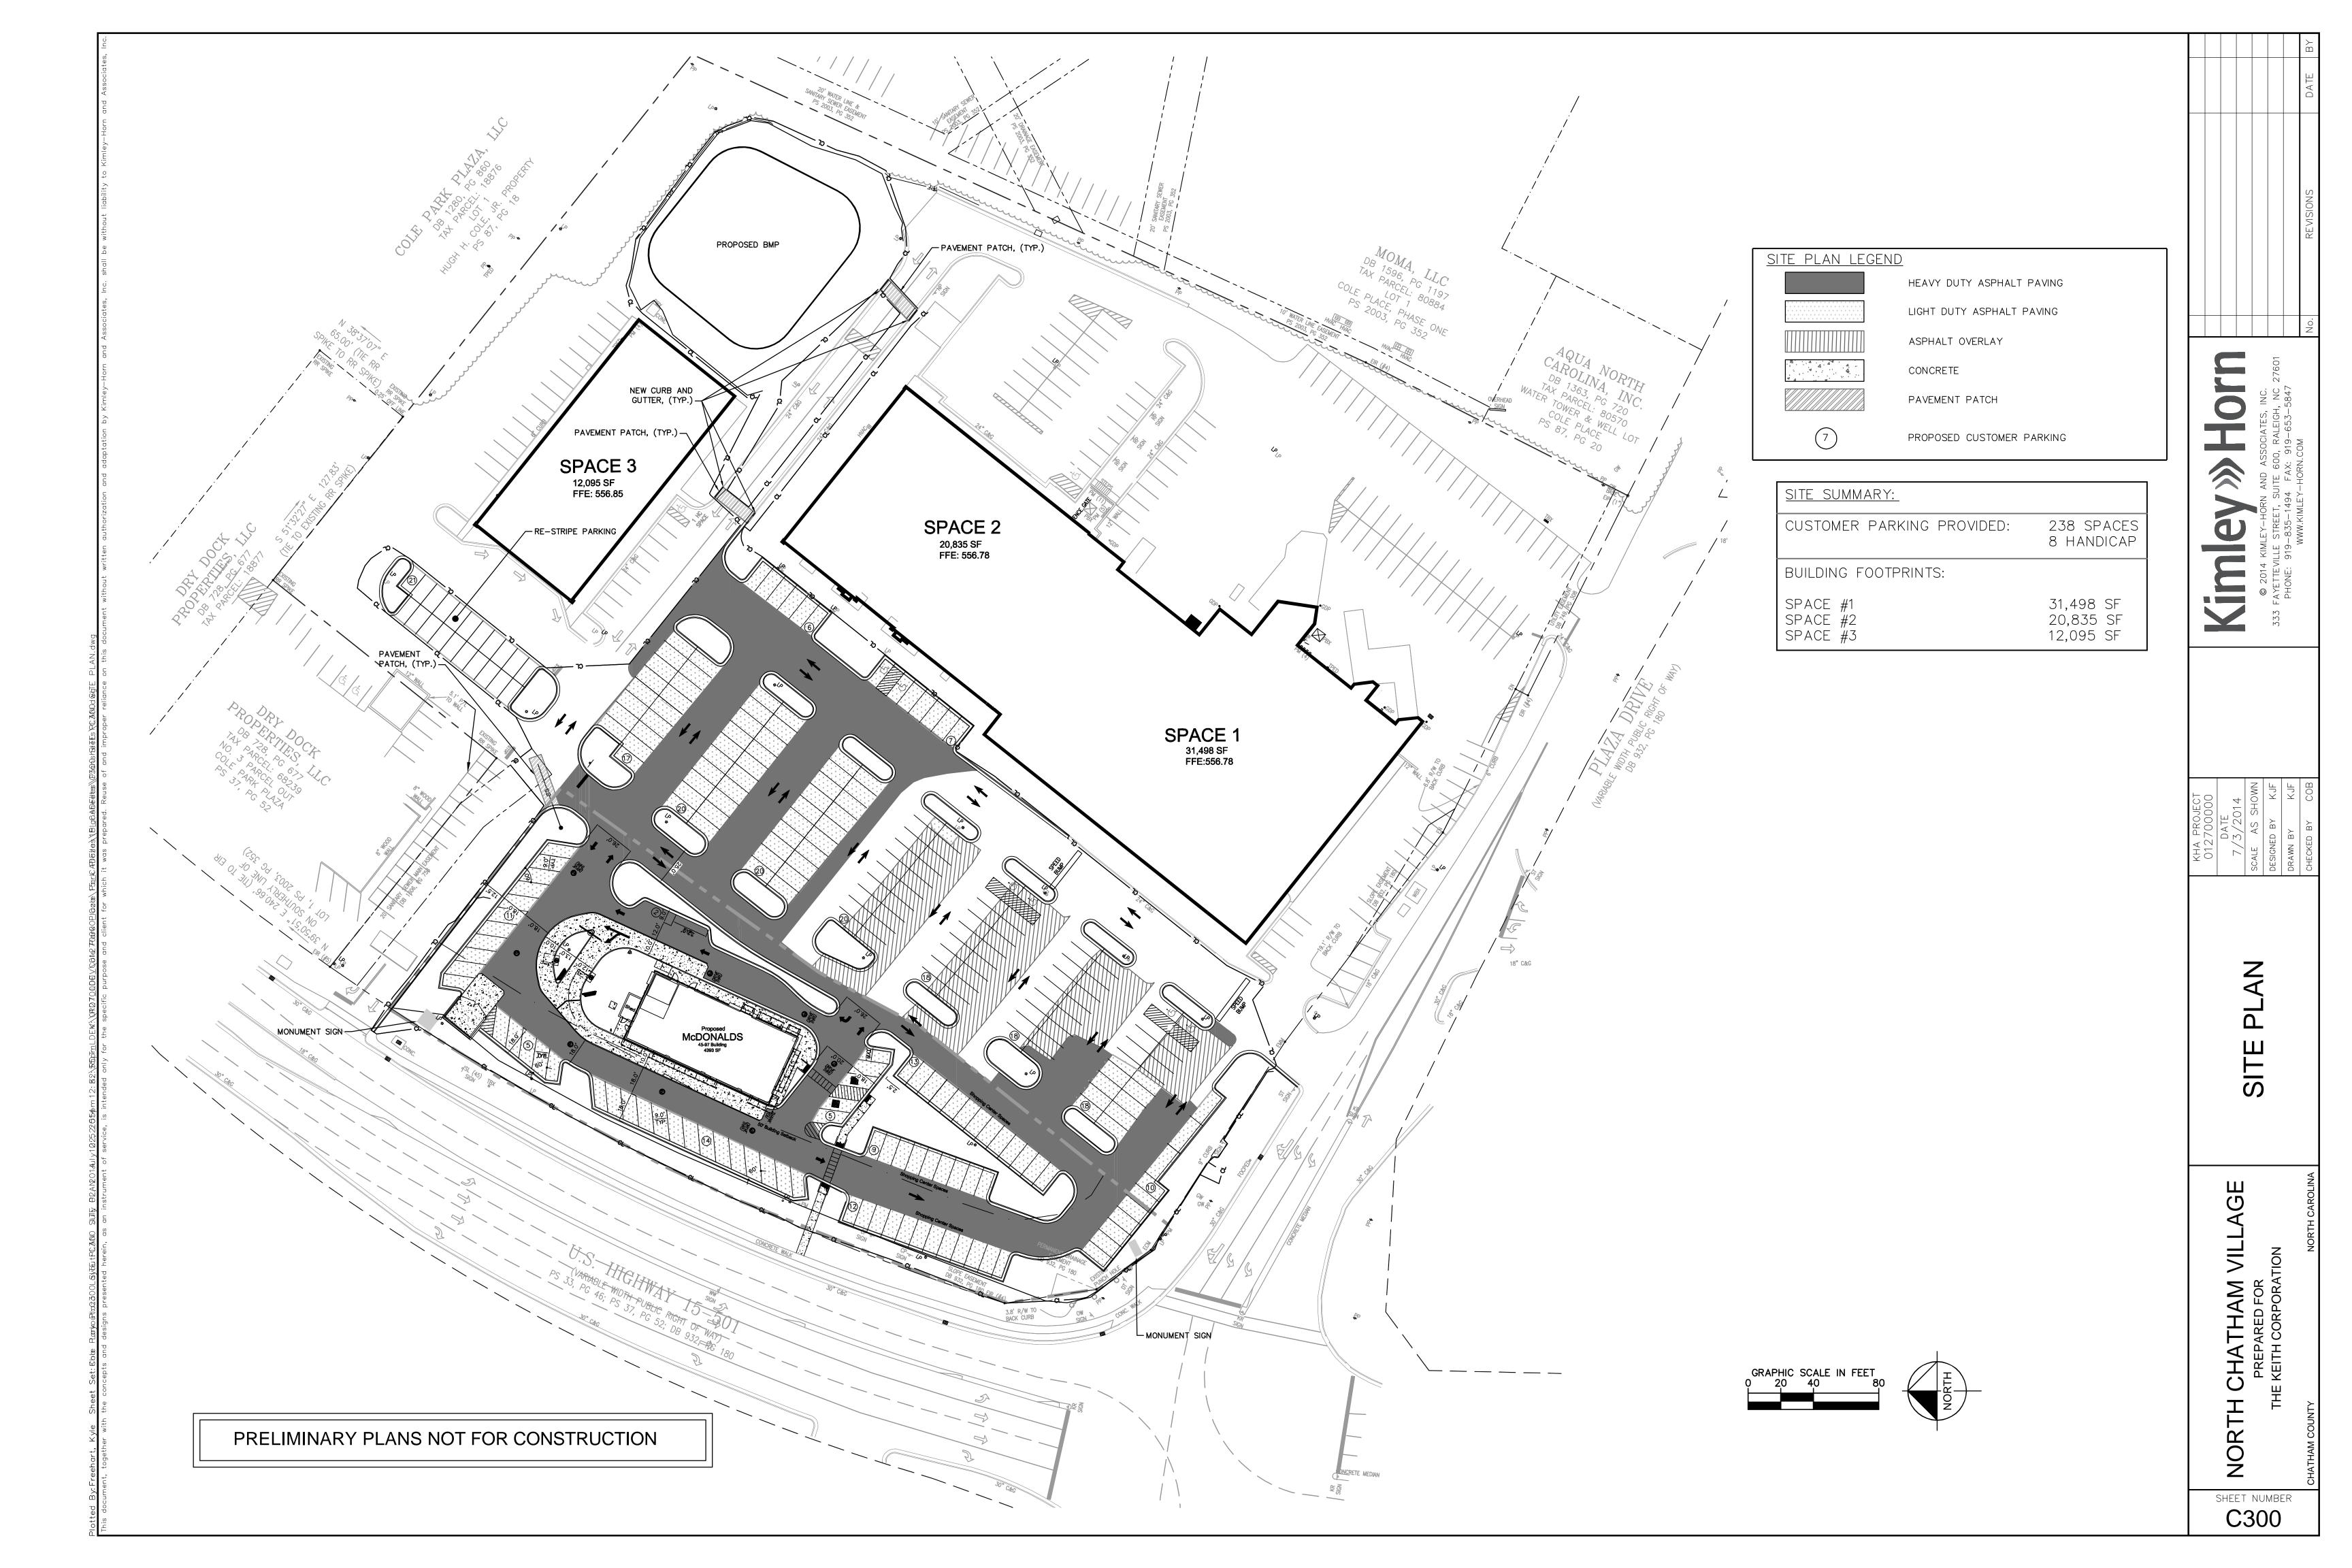

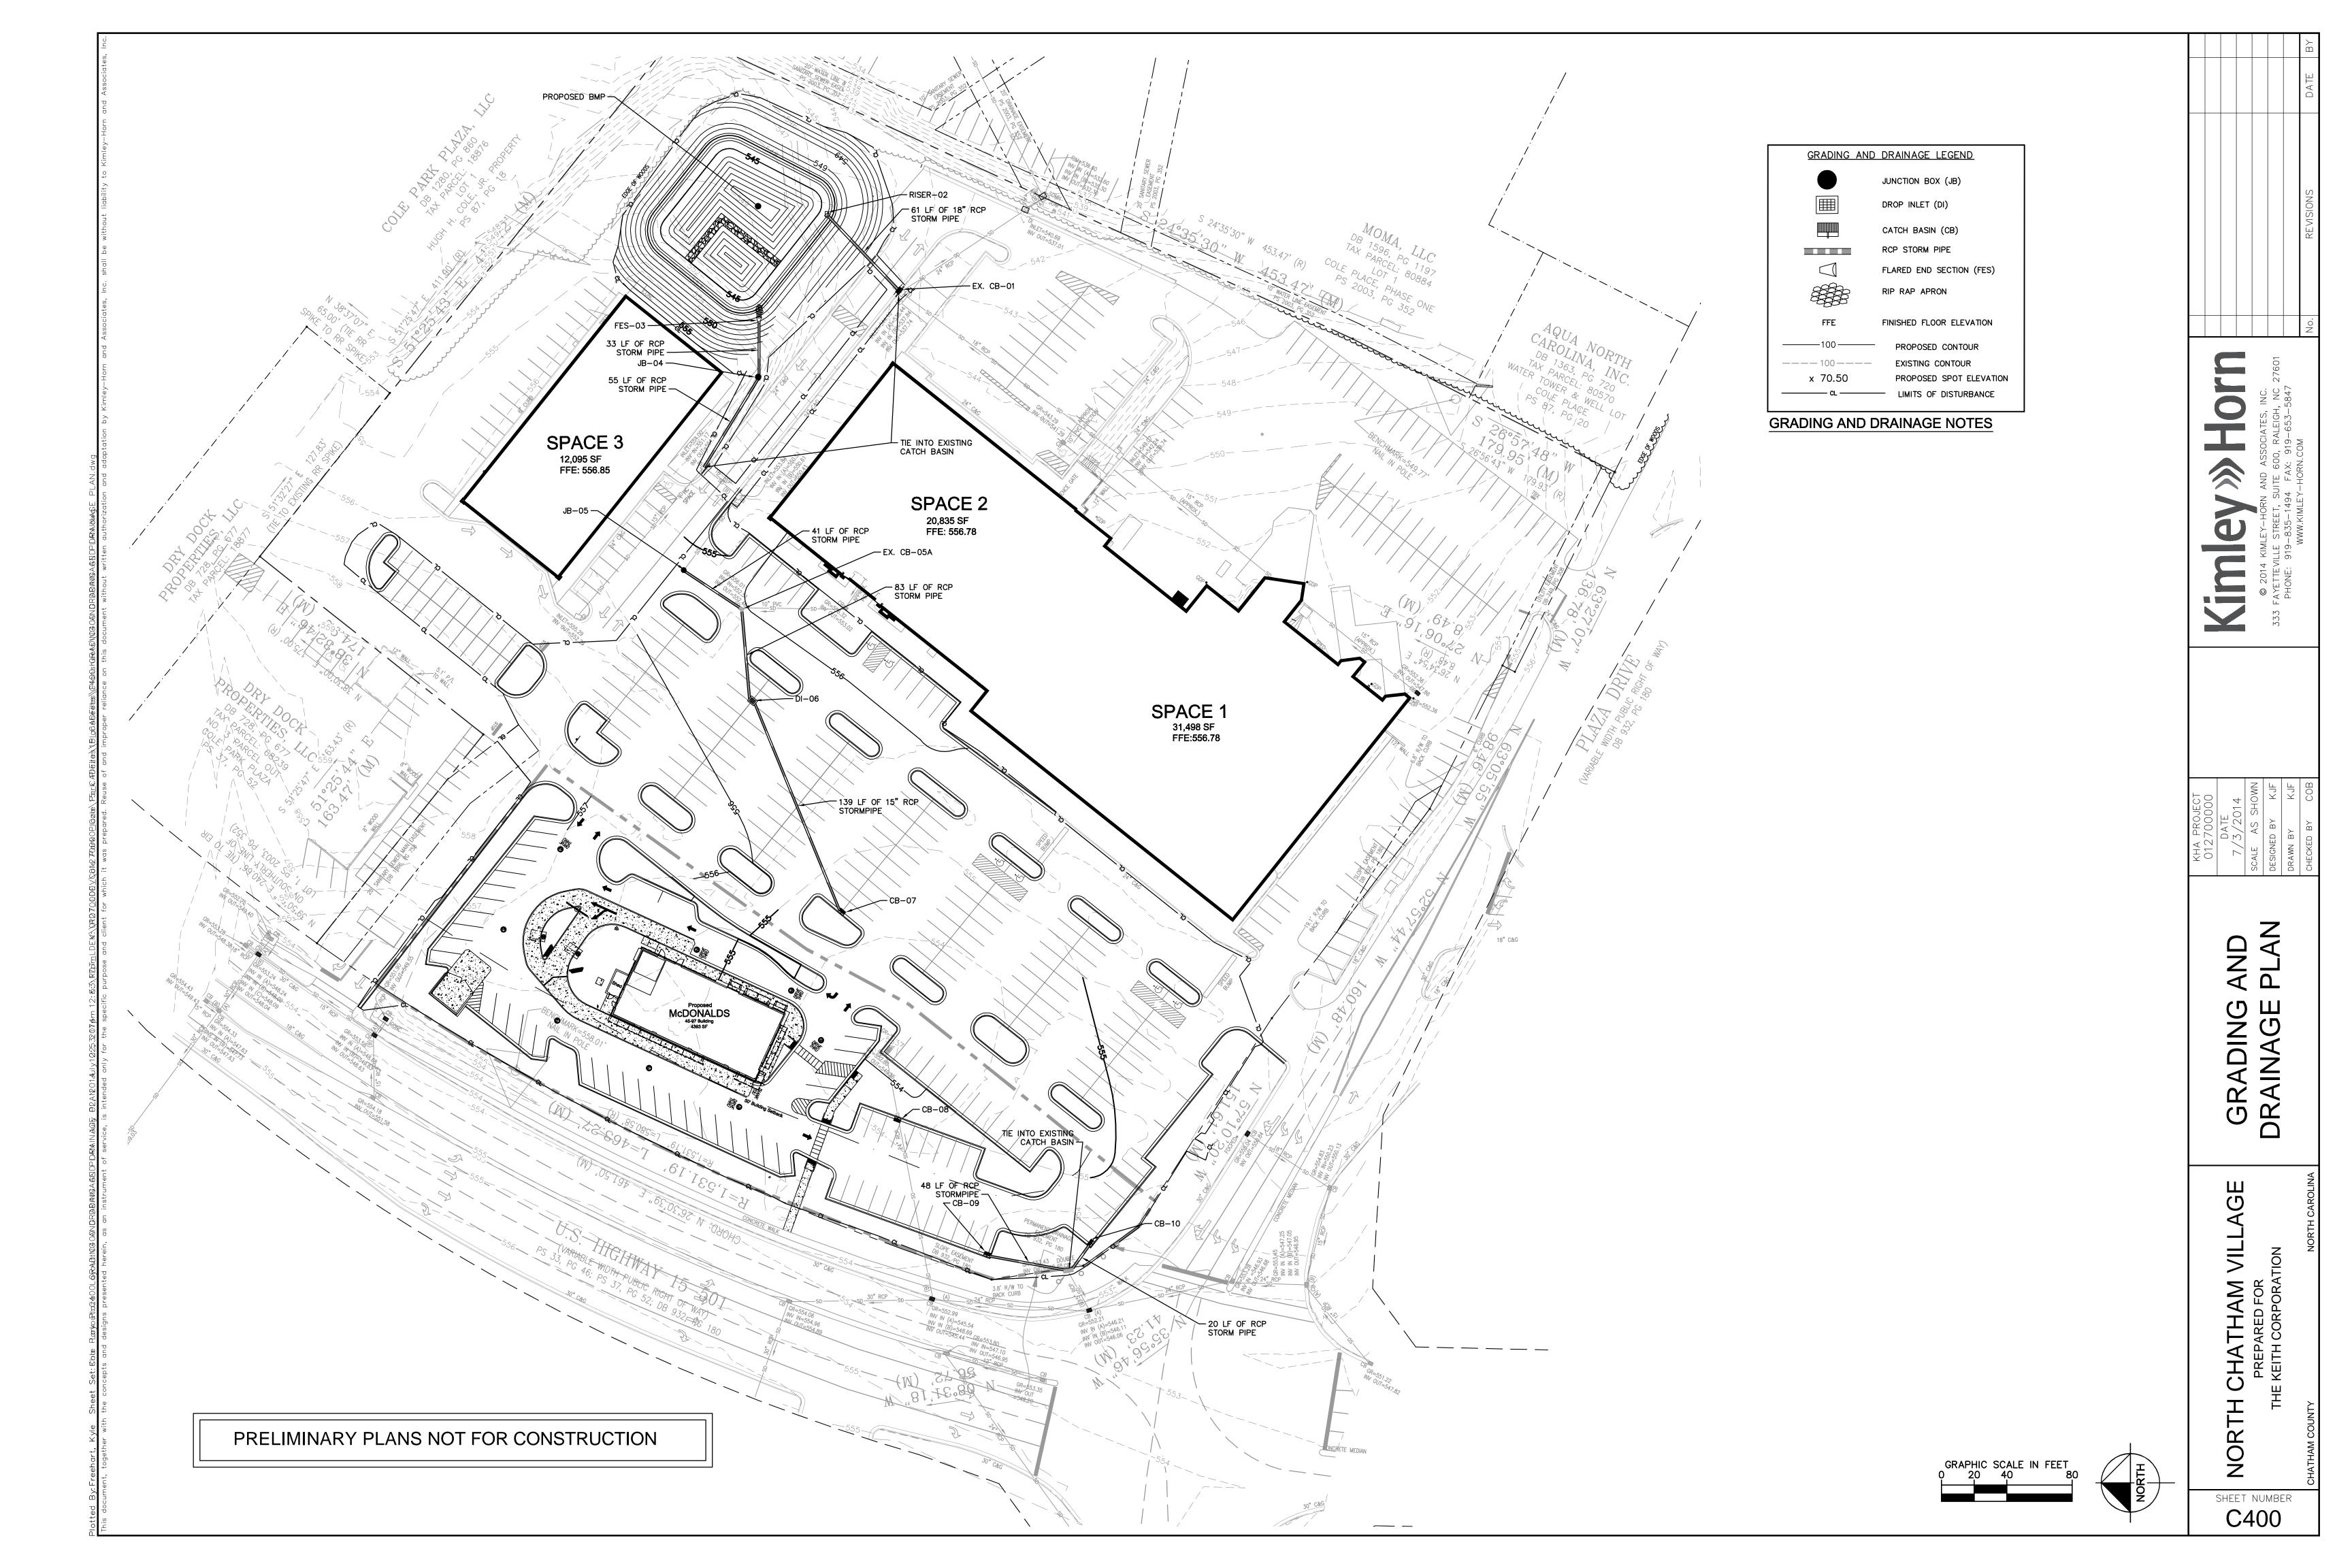

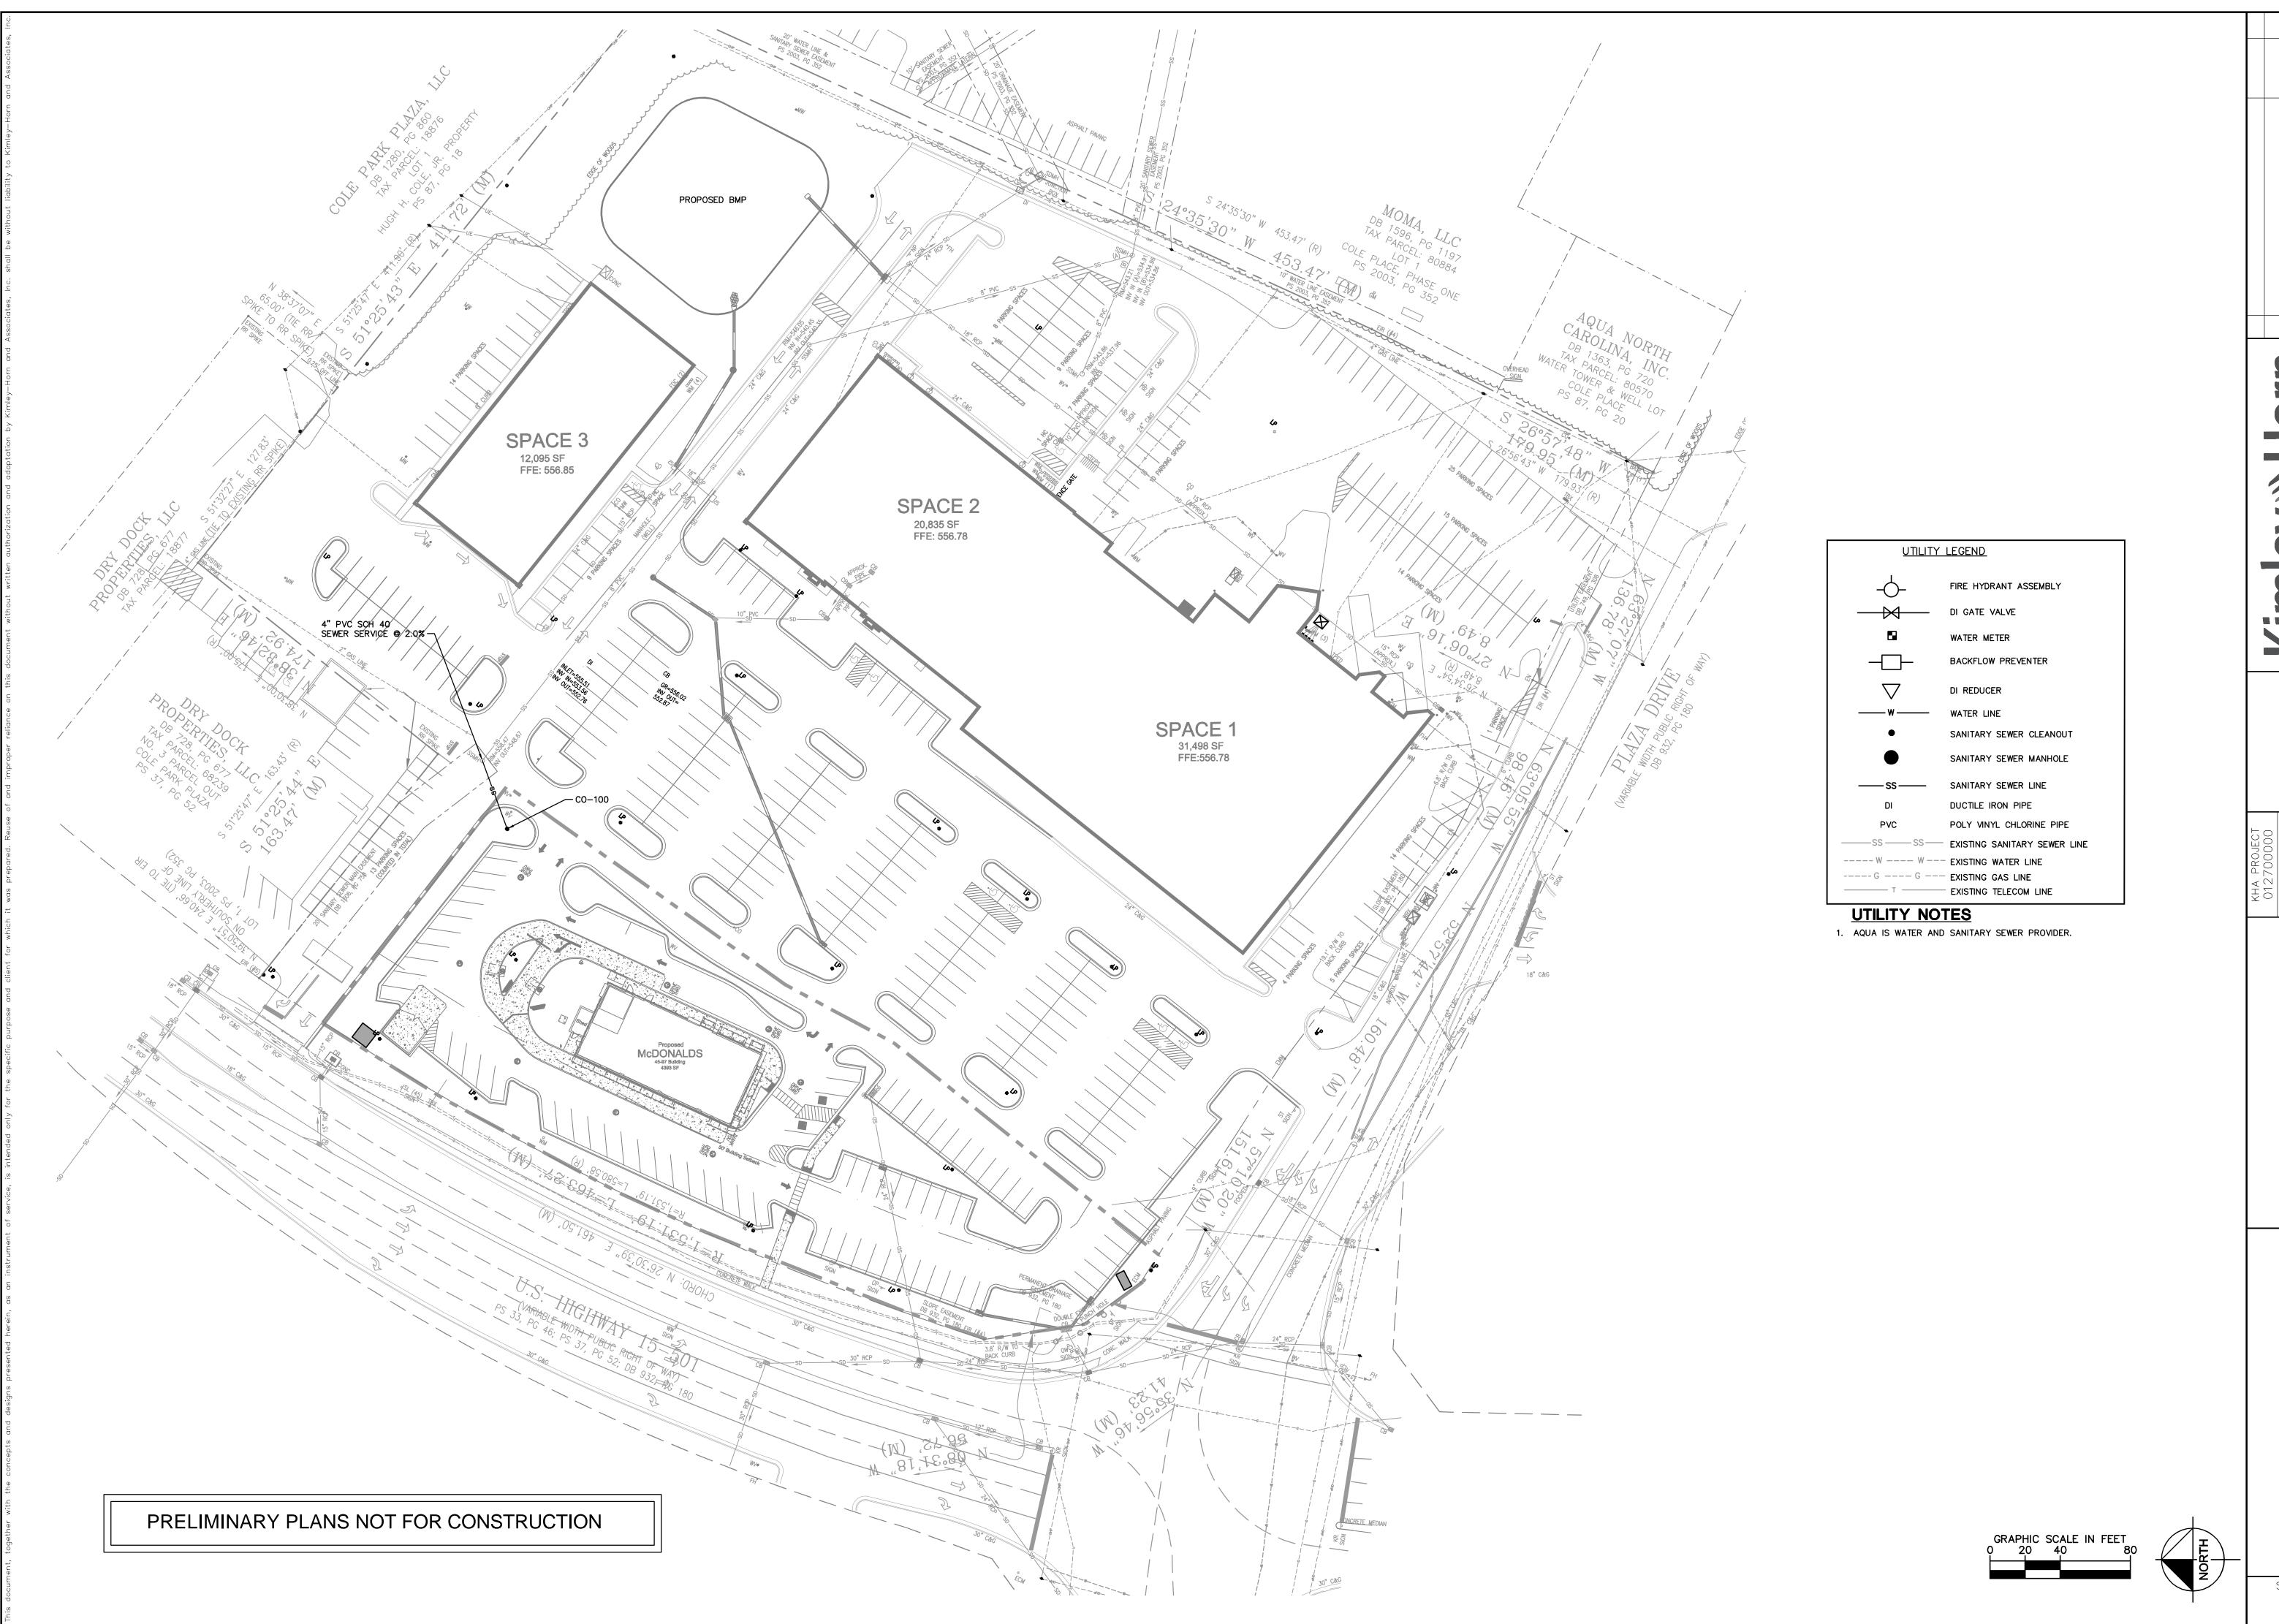SHEET NUMBER C500

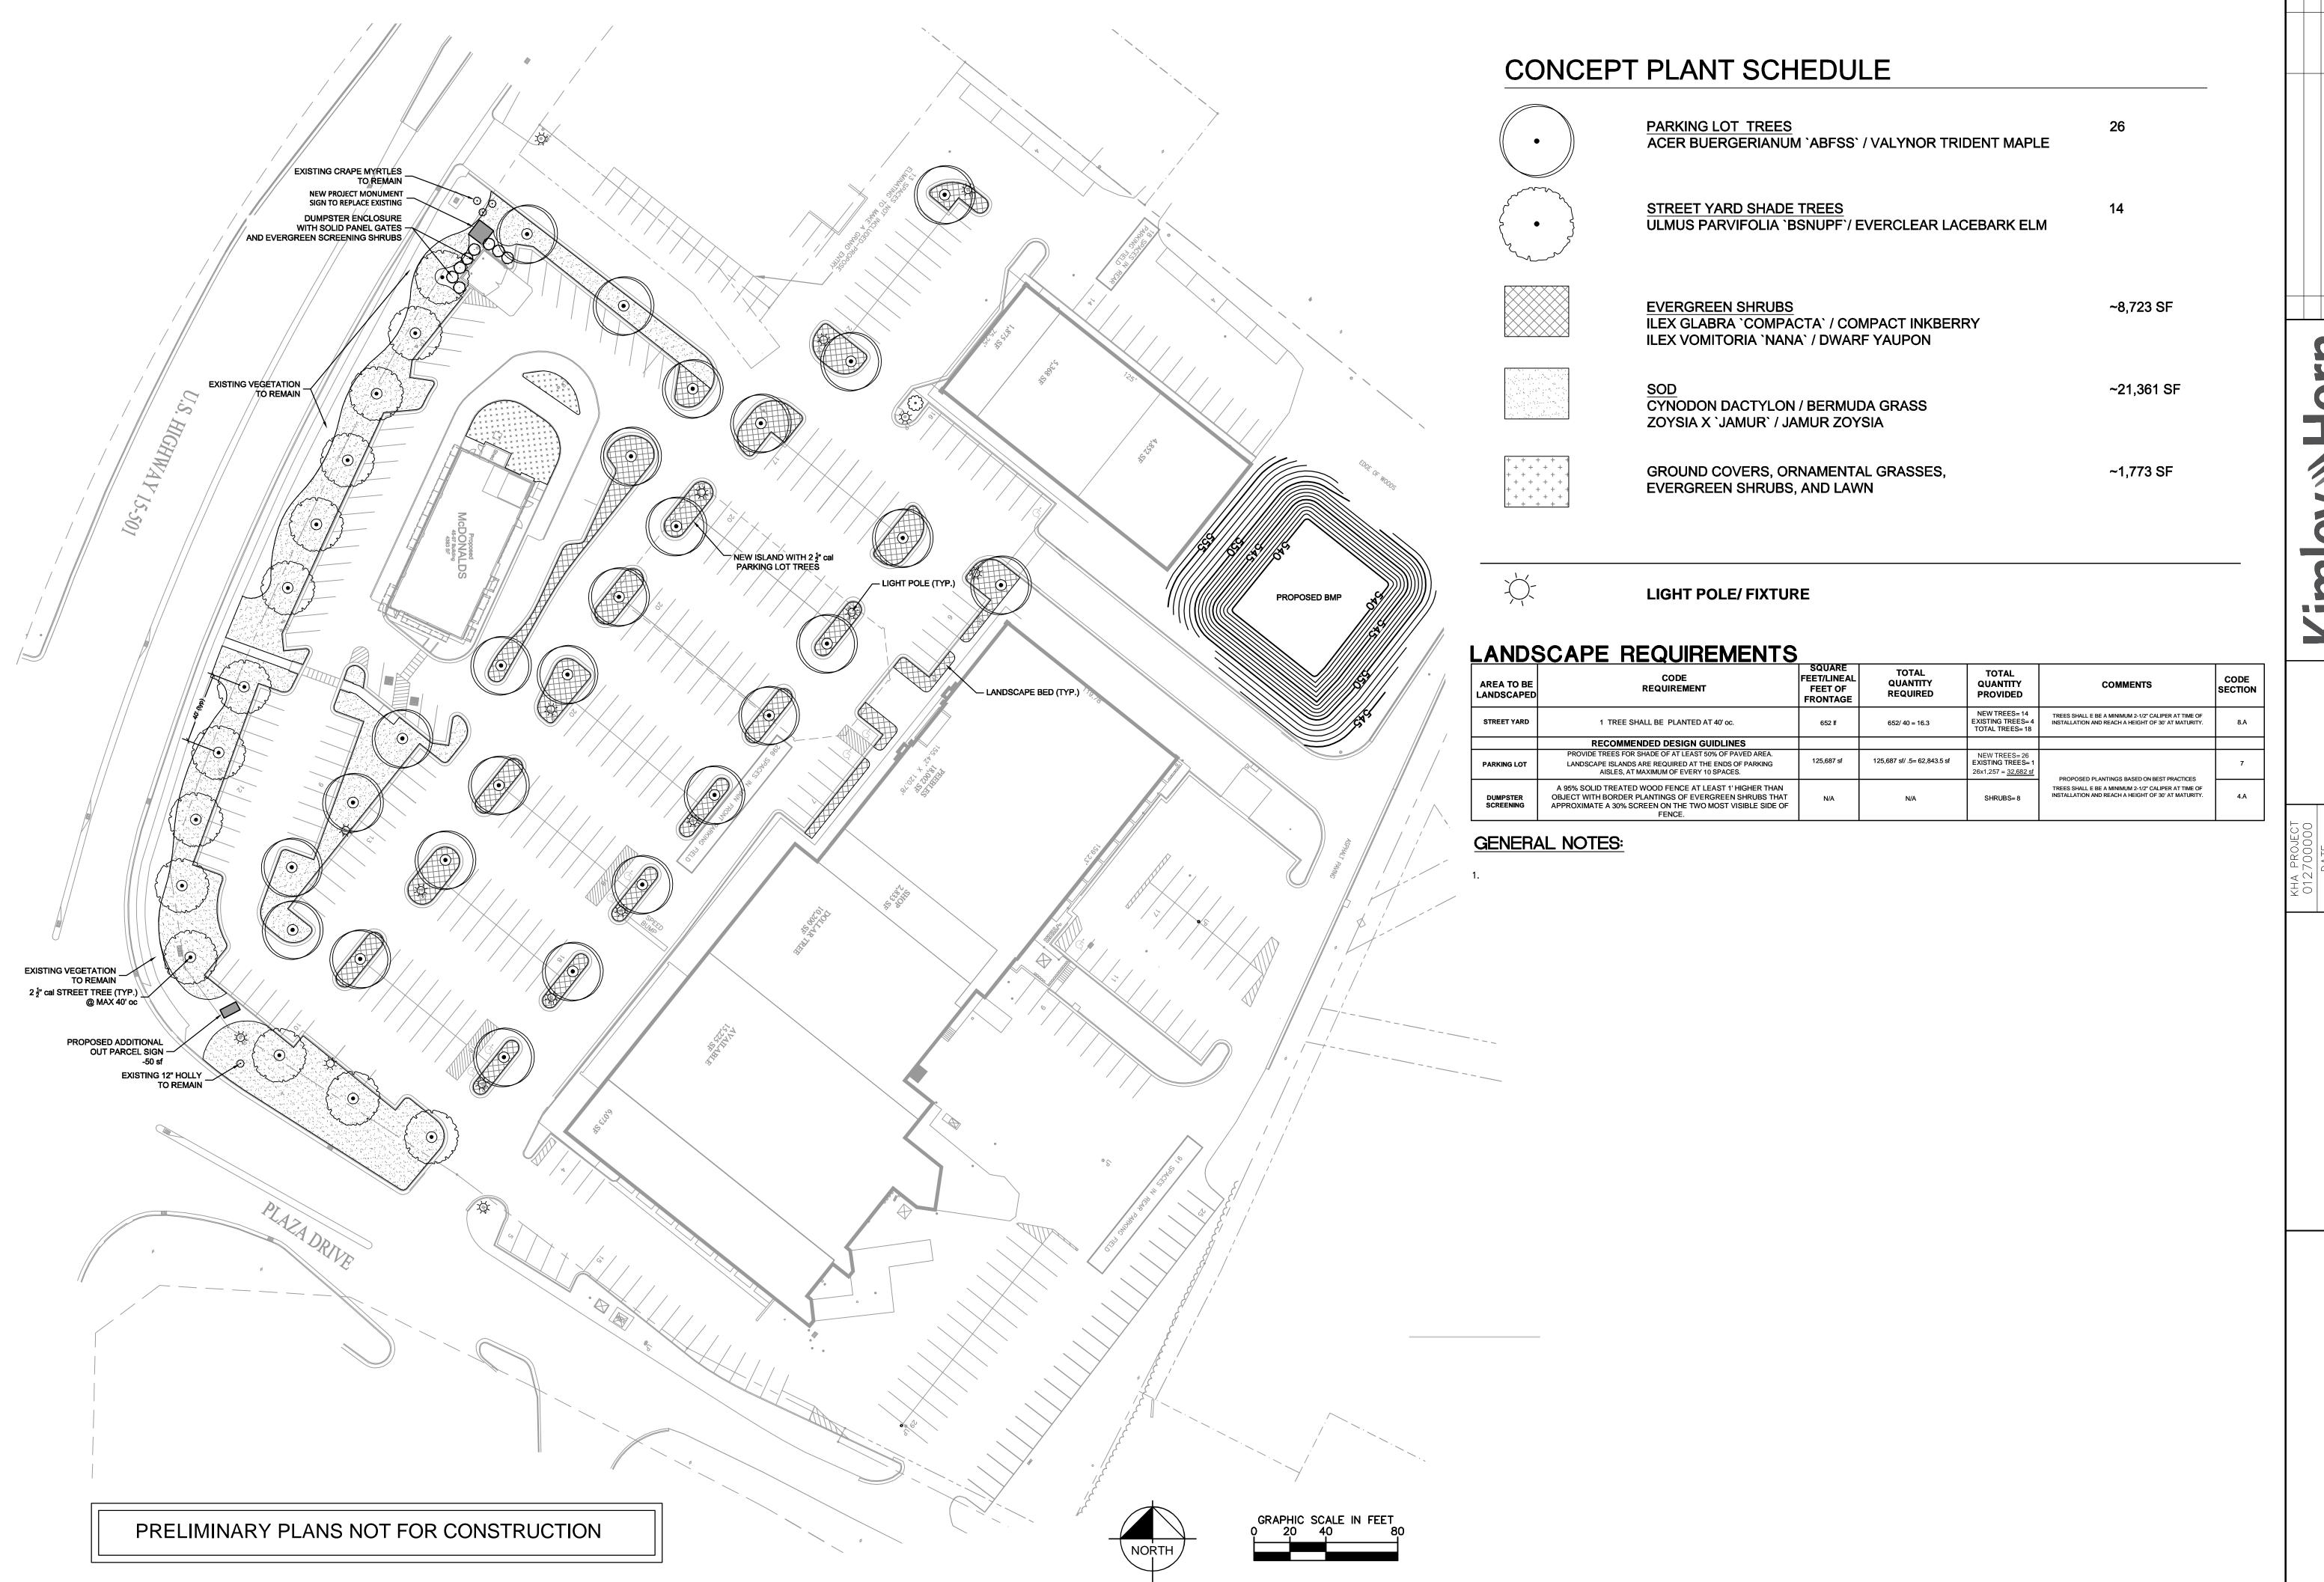

No. REVISIONS DATE

KIMLEY—HORN AND ASSOCIATES, INC. LLE STREET, SUITE 600, RALEIGH, NC 27601 919—835—1494 FAX: 919—653—5847 WWW.KIMLEY—HORN.COM


AS SHOWN
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PLAN SCA

LANDSCAPE P


PREPARED FOR THE KEITH CORPORATION


SHEET NUMBER

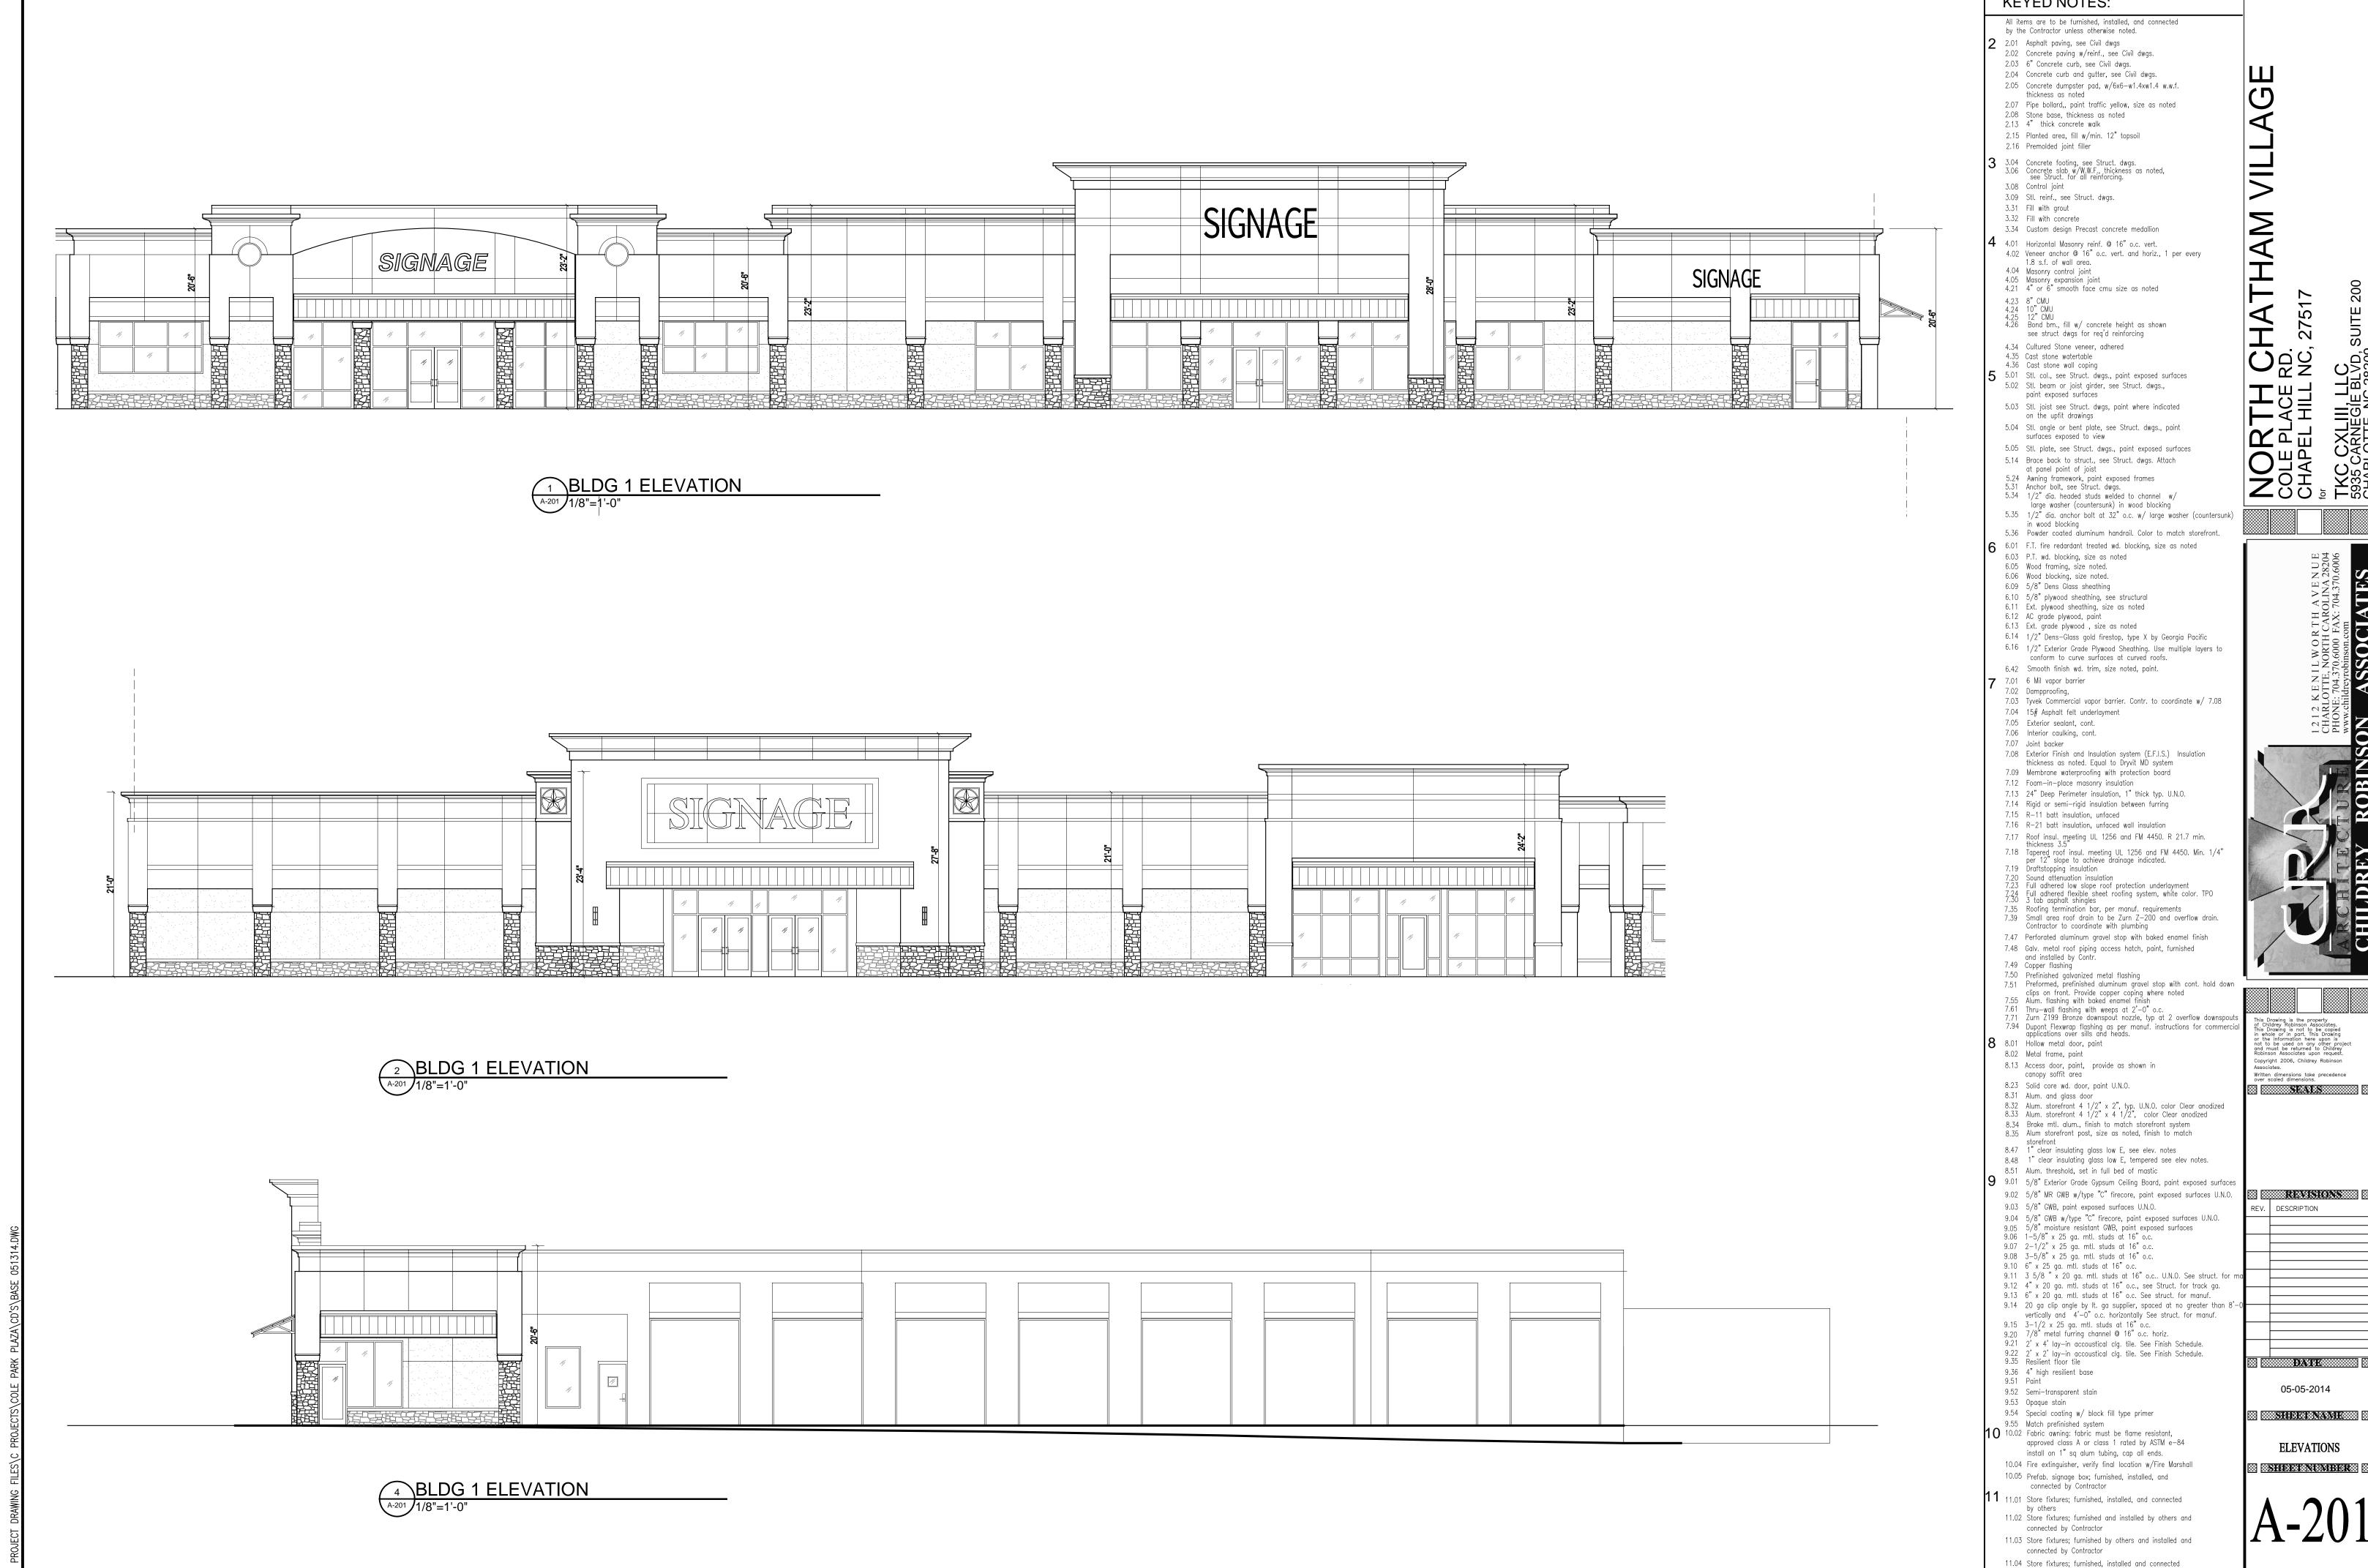

**KEYED NOTES:** 

15 15.01 Master water meter, see Plumbing dwgs.

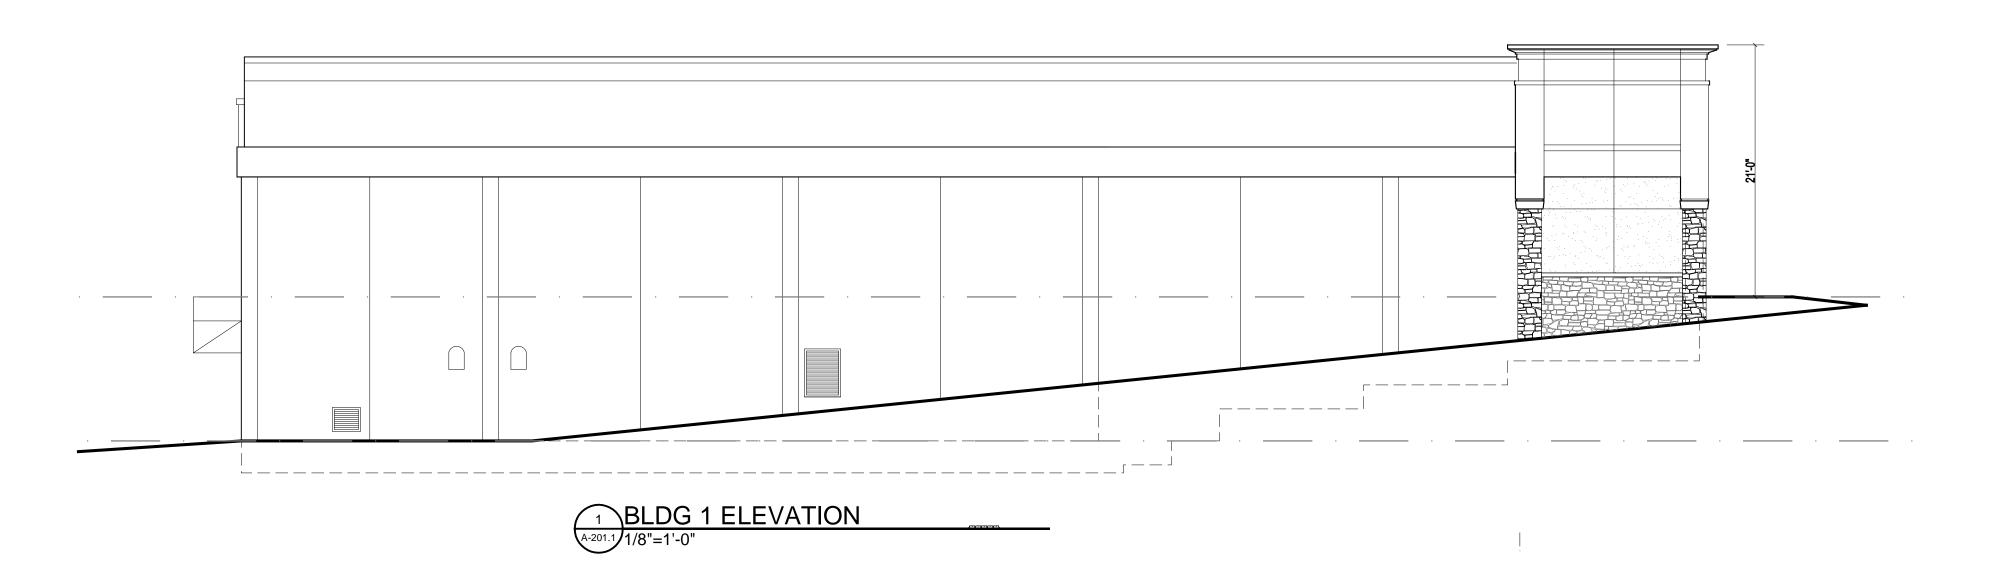

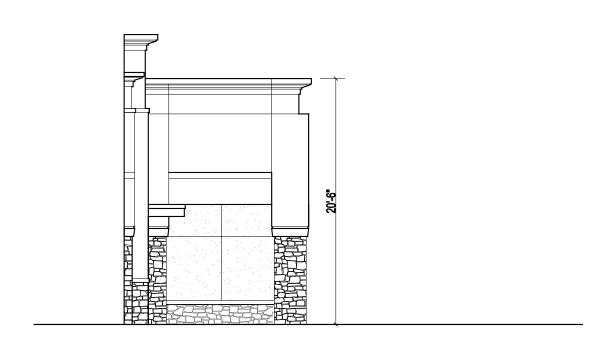

2 BLDG 1 ELEVATION

2 27 This Drawing is the property of Childrey Robinson Associates. This Drawing is not to be copied in whole or in part. This Drawing or the information here upon is not to be used on any other project and must be returned to Childrey Robinson Associates upon request. Copyright 2006, Childrey Robinson Associates Written dimensions take precedence over scaled dimensions. SEALS REV. DESCRIPTION 9.22 2' x 2' lay-in accoustical clg. tile. See Finish Schedule. 9.35 Resilient floor tile DATE 9.36 4" high resilient base 9.52 Semi-transparent stain 9.53 Opaque stain 9.54 Special coating w/ block fill type primer SHEETINAME **ELEVATIONS** 

**KEYED NOTES:** All items are to be furnished, installed, and connected by the Contractor unless otherwise noted. 2 2.01 Asphalt paving, see Civil dwgs 2.02 Concrete paying w/reinf., see Civil dwgs. 2.03 6" Concrete curb, see Civil dwgs. 2.04 Concrete curb and gutter, see Civil dwgs. 2.05 Concrete dumpster pad, w/6x6-w1.4xw1.4 w.w.f. thickness as noted 2.07 Pipe bollard,, paint traffic yellow, size as noted 2.08 Stone base, thickness as noted 2.13 4" thick concrete walk 2.15 Planted area, fill w/min. 12" topsoil 2.16 Premolded joint filler 3.04 Concrete footing, see Struct. dwgs.
3.06 Concrete slab w/W.W.F., thickness as noted, see Struct. for all reinforcing. 3.08 Control joint 3.09 Stl. reinf., see Struct. dwgs. 3.31 Fill with grout 3.32 Fill with concrete 3.34 Custom design Precast concrete medallion 4 4.01 Horizontal Masonry reinf. @ 16" o.c. vert. 4.02 Veneer anchor @ 16" o.c. vert. and horiz., 1 per every 1.8 s.f. of wall area. 4.04 Masonry control joint 4.05 Masonry expansion joint 4.21 4" or 6" smooth face cmu size as noted 4.23 8" CMU 4.26 Bond bm., fill w/ concrete height as shown see struct dwgs for req'd reinforcing 4.34 Cultured Stone veneer, adhered 4.35 Cast stone watertable 4.36 Cast stone wall coping 5 5.01 Stl. col., see Struct. dwgs., paint exposed surfaces 5.02 Stl. beam or joist girder, see Struct. dwgs., paint exposed surfaces 5.03 Stl. joist see Struct. dwgs, paint where indicated on the upfit drawings 5.04 Stl. angle or bent plate, see Struct. dwgs., paint surfaces exposed to view 5.05 Stl. plate, see Struct. dwgs., paint exposed surfaces 5.14 Brace back to struct., see Struct. dwgs. Attach at panel point of joist 5.24 Awning framework, paint exposed frames 5.31 Anchor bolt, see Struct. dwgs. 5.34 1/2" dia. headed studs welded to channel w/ large washer (countersunk) in wood blocking 5.35 1/2" dia. anchor bolt at 32" o.c. w/ large washer (countersunk) in wood blocking 5.36 Powder coated aluminum handrail. Color to match storefront. 6.01 F.T. fire redardant treated wd. blocking, size as noted 6.03 P.T. wd. blocking, size as noted 6.05 Wood framing, size noted. 6.06 Wood blocking, size noted. 6.09 5/8" Dens Glass sheathing 6.10 5/8" plywood sheathing, see structural 6.11 Ext. plywood sheathing, size as noted 6.12 AC grade plywood, paint 6.13 Ext. grade plywood , size as noted 6.14 1/2" Dens-Glass gold firestop, type X by Georgia Pacific 6.16 1/2" Exterior Grade Plywood Sheathing. Use multiple layers to conform to curve surfaces at curved roofs. 6.42 Smooth finish wd. trim, size noted, paint. **7** 7.01 6 Mil vapor barrier 7.02 Dampproofing, 7.03 Tyvek Commercial vapor barrier. Contr. to coordinate w/ 7.08 7.04 15# Asphalt felt underlayment 7.05 Exterior sealant, cont. 7.06 Interior caulking, cont. 7.07 Joint backer 7.08 Exterior Finish and Insulation system (E.F.I.S.) Insulation thickness as noted. Equal to Dryvit MD system 7.09 Membrane waterproofing with protection board 7.12 Foam—in—place masonry insulation 7.13 24" Deep Perimeter insulation, 1" thick typ. U.N.O. 7.14 Rigid or semi-rigid insulation between furring 7.15 R-11 batt insulation, unfaced 7.16 R-21 batt insulation, unfaced wall insulation 7.17 Roof insul. meeting UL 1256 and FM 4450. R 21.7 min. thickness 3.5" 7.18 Tapered roof insul. meeting UL 1256 and FM 4450. Min. 1/4" per 12" slope to achieve drainage indicated. 7.19 Draftstopping insulation 7.20 Sound attenuation insulation
7.23 Full adhered low slope roof protection underlayment
7.24 Full adhered flexible sheet roofing system, white color. TPO
7.30 3 tab asphalt shingles 7.35 Roofing termination bar, per manuf. requirements 7.39 Small area roof drain to be Zurn Z—200 and overflow drain. Contractor to coordinate with plumbing 7.47 Perforated aluminum gravel stop with baked enamel finish 7.48 Galv. metal roof piping access hatch, paint, furnished and installed by Contr.
7.49 Copper flashing 7.50 Prefinished galvanized metal flashing 7.51 Preformed, prefinished aluminum gravel stop with cont. hold down clips on front. Provide copper coping where noted 7.55 Alum. flashing with baked enamel finish 7.61 Thru-wall flashing with weeps at 2'-0" o.c. 7.71 Zurn Z199 Bronze downspout nozzle, typ at 2 overflow downspouts 7.94 Dupont Flexwrap flashing as per manuf. instructions for commercia applications over sills and heads. 8.01 Hollow metal door, paint 8.02 Metal frame, paint 8.13 Access door, paint, provide as shown in canopy soffit area 8.23 Solid core wd. door, paint U.N.O. 8.31 Alum. and glass door 8.32 Alum. storefront 4 1/2" x 2", typ. U.N.O. color Clear anodized 8.33 Alum. storefront 4 1/2" x 4 1/2", color Clear anodized 8.34 Brake mtl. alum., finish to match storefront system 8.35 Alum storefront post, size as noted, finish to match storefront 8.47 1" clear insulating glass low E, see elev. notes 8.48 1" clear insulating glass low E, tempered see elev notes. 8.51 Alum. threshold, set in full bed of mastic 9 9.01 5/8" Exterior Grade Gypsum Ceiling Board, paint exposed surfaces 9.02 5/8" MR GWB w/type "C" firecore, paint exposed surfaces U.N.O. 9.03 5/8" GWB, paint exposed surfaces U.N.O. 9.04 5/8" GWB w/type "C" firecore, paint exposed surfaces U.N.O. 9.05 5/8" moisture resistant GWB, paint exposed surfaces 9.06 1-5/8" x 25 ga. mtl. studs at 16" o.c. 9.07 2-1/2" x 25 ga. mtl. studs at 16" o.c. 9.08 3-5/8" x 25 ga. mtl. studs at 16" o.c. 9.10 6" x 25 ga. mtl. studs at 16" o.c. 9.11 3 5/8 " x 20 ga. mtl. studs at 16" o.c.. U.N.O. See struct. for ma 9.12 4" x 20 ga. mtl. studs at 16" o.c., see Struct. for track ga. 9.13 6" x 20 ga. mtl. studs at 16" o.c. See struct. for manuf. 9.14 20 ga clip angle by It. ga supplier, spaced at no greater than 8'vertically and 4'-0" o.c. horizontally See struct. for manuf. 9.15 3-1/2 x 25 ga. mtl. studs at 16" o.c. 9.20 7/8" metal furring channel @ 16" o.c. horiz. 9.21 2' x 4' lay—in accoustical clg. tile. See Finish Schedule.

05-05-2014

9.55 Match prefinished system 10 10.02 Fabric awning: fabric must be flame resistant, approved class A or class 1 rated by ASTM e-84 install on 1" sq alum tubing, cap all ends.


9.51 Paint

10.04 Fire extinguisher, verify final location w/Fire Marshall 10.05 Prefab. signage box; furnished, installed, and connected by Contractor

11 11.01 Store fixtures; furnished, installed, and connected bv others 11.02 Store fixtures; furnished and installed by others and connected by Contractor

11.03 Store fixtures; furnished by others and installed and connected by Contractor 11.04 Store fixtures; furnished, installed and connected

15 15.01 Master water meter, see Plumbing dwgs.

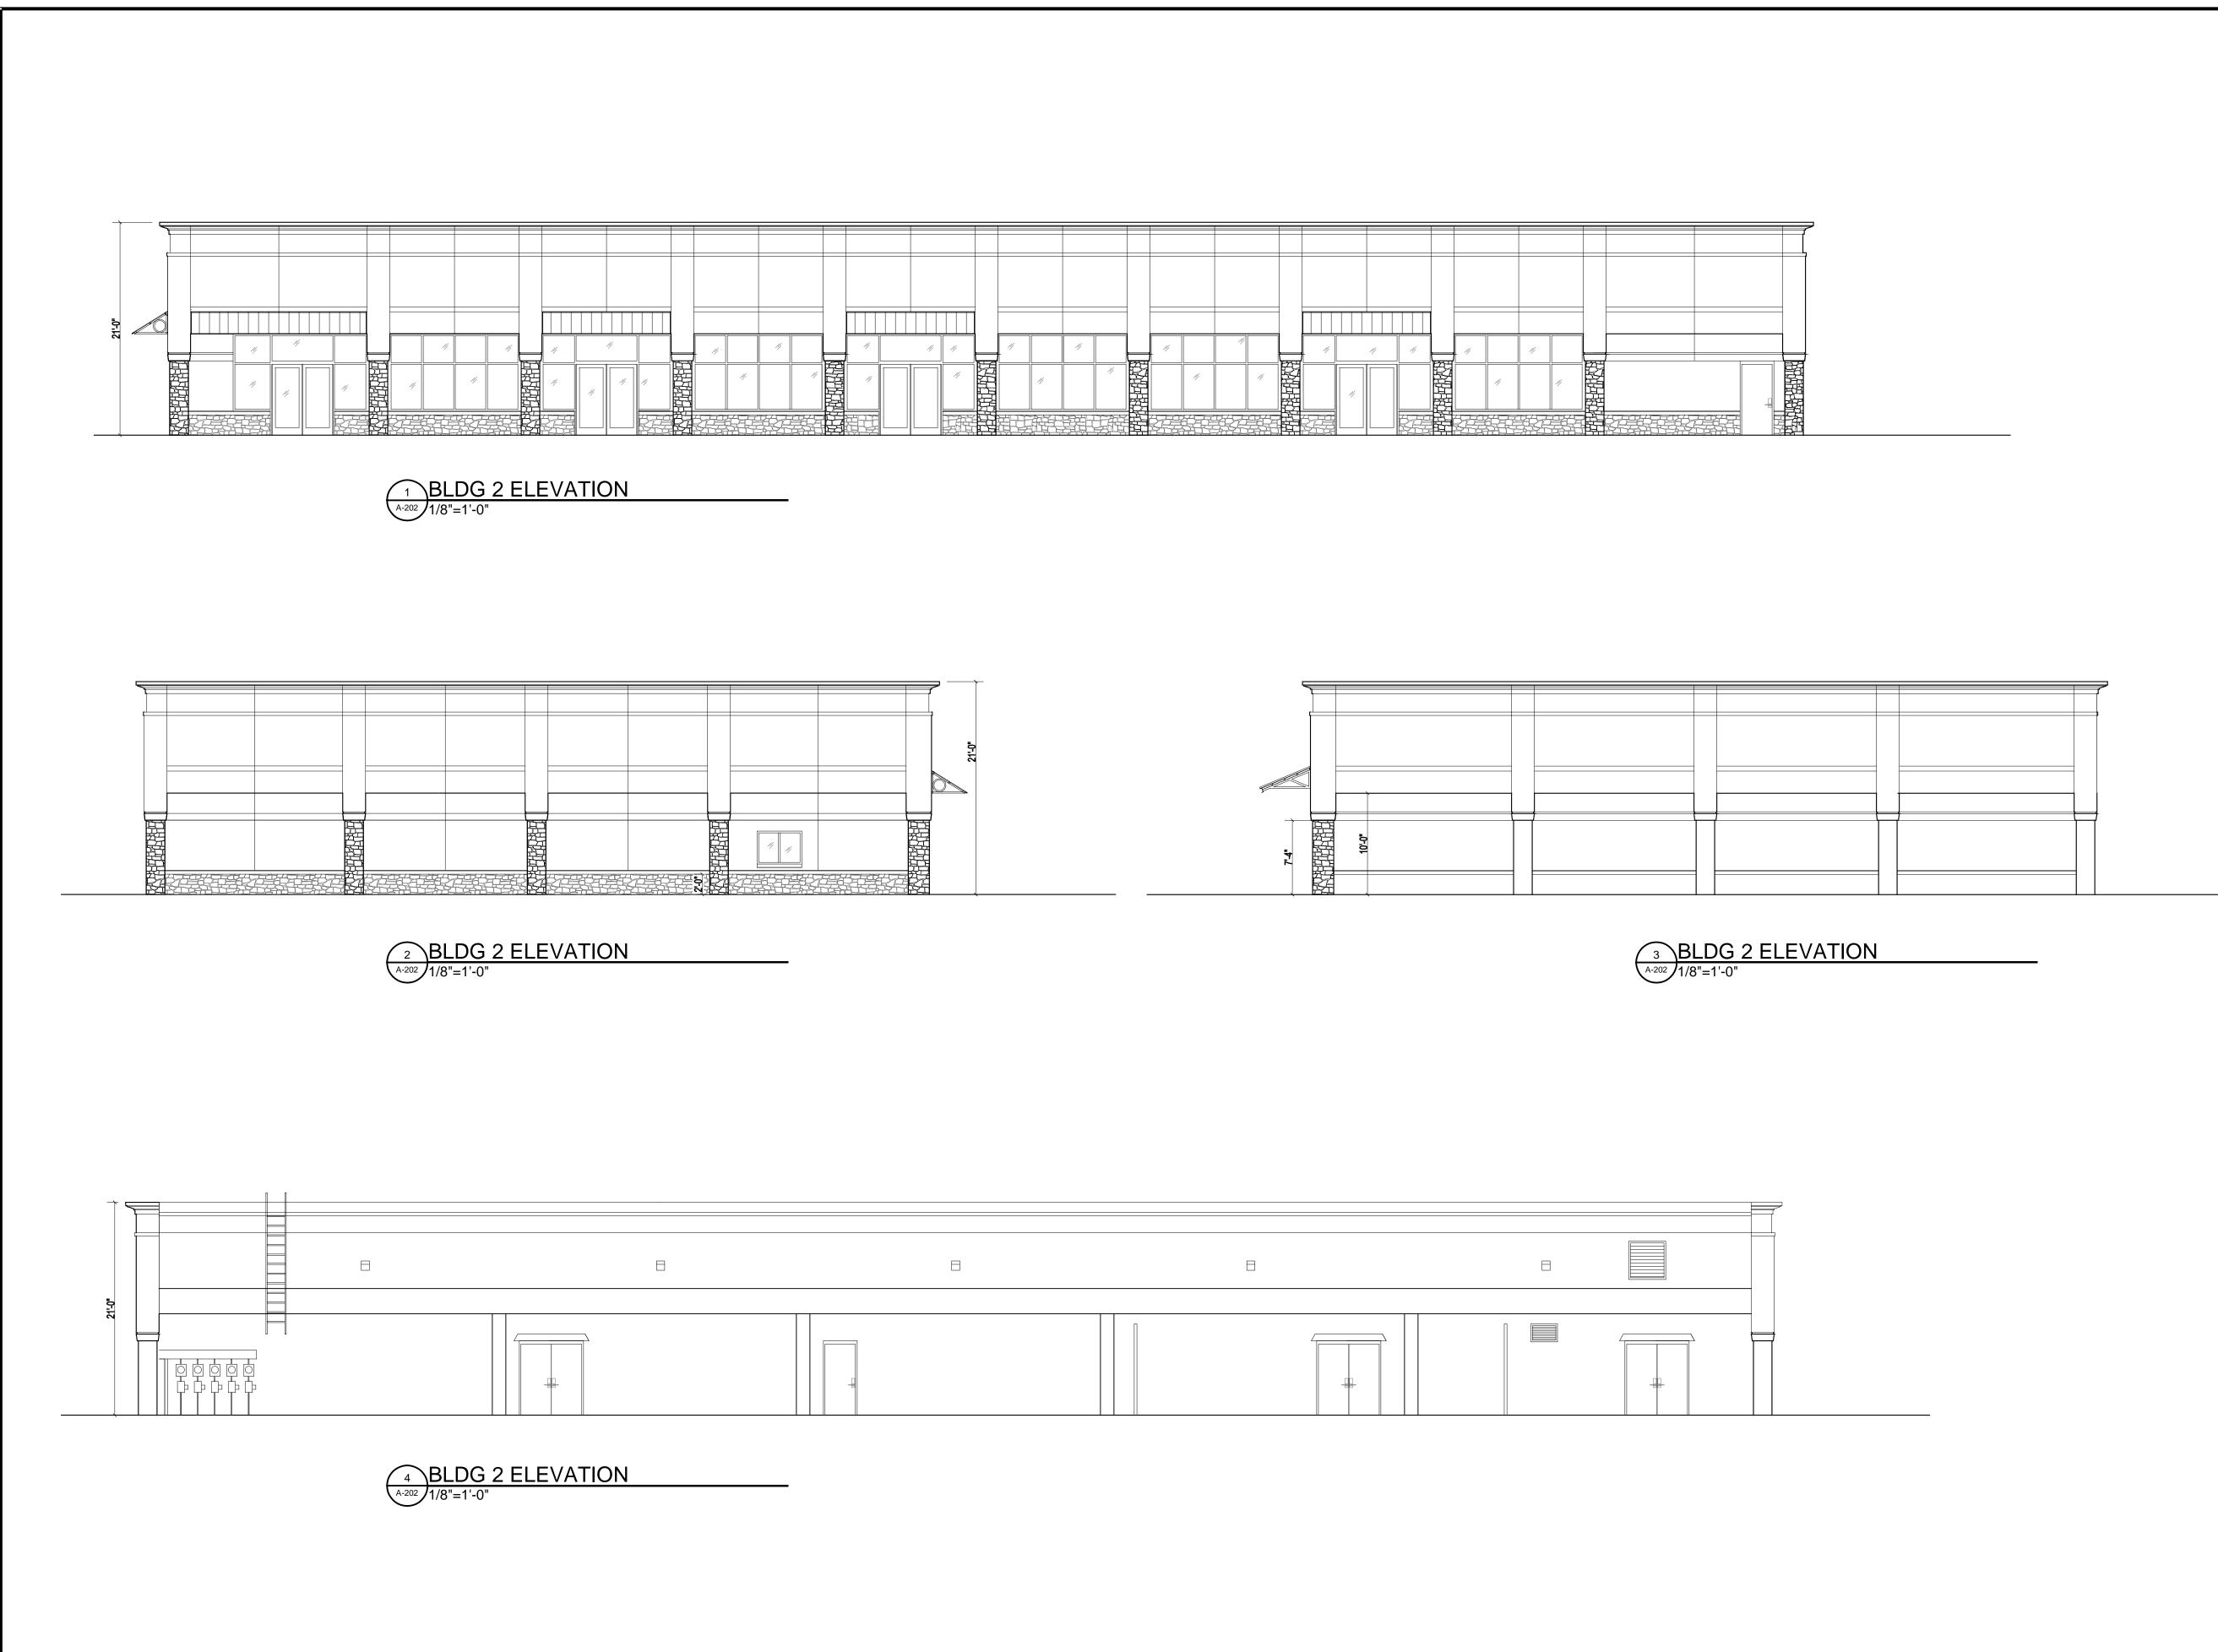

All items are to be furnished, installed, and connected by the Contractor unless otherwise noted. 2 2.01 Asphalt paving, see Civil dwgs 2.02 Concrete paving w/reinf., see Civil dwgs. 2.03 6" Concrete curb, see Civil dwgs. 2.04 Concrete curb and gutter, see Civil dwgs. 2.05 Concrete dumpster pad, w/6x6-w1.4xw1.4 w.w.f. thickness as noted 2.07 Pipe bollard,, paint traffic yellow, size as noted 2.08 Stone base, thickness as noted 2.13 4" thick concrete walk 2.15 Planted area, fill w/min. 12" topsoil 2.16 Premolded joint filler 3.04 Concrete footing, see Struct. dwgs.
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7.19 Draftstopping insulation 7.20 Sound attenuation insulation
7.23 Full adhered low slope roof protection underlayment
7.24 Full adhered flexible sheet roofing system, white color. TPO
7.30 3 tab asphalt shingles 7.35 Roofing termination bar, per manuf requirements 7.39 Small area roof drain to be Zurn Z—200 and overflow drain.

Contractor to coordinate with plumbing 7.47 Perforated aluminum gravel stop with baked enamel finish 7.48 Galv. metal roof piping access hatch, paint, furnished and installed by Contr.
7.49 Copper flashing 7.50 Prefinished galvanized metal flashing 7.51 Preformed, prefinished aluminum gravel stop with cont. hold down clips on front. Provide copper coping where noted 7.55 Alum. flashing with baked enamel finish 7.61 Thru-wall flashing with weeps at 2'-0" o.c. This Drawing is the property of Childrey Robinson Associates. This Drawing is not to be copied in whole or in part. This Drawing or the information here upon is not to be used on any other project and must be returned to Childrey Robinson Associates upon request. Copyright 2006, Childrey Robinson Associates when the control of the con 7.71 Zurn Z199 Bronze downspout nozzle, typ at 2 overflow downspouts 7.94 Dupont Flexwrap flashing as per manuf. instructions for commercia applications over sills and heads. 8.01 Hollow metal door, paint 8.02 Metal frame, paint 8.13 Access door, paint, provide as shown in canopy soffit area 8.23 Solid core wd. door, paint U.N.O. SEALS 8.31 Alum. and glass door 8.32 Alum. storefront 4 1/2" x 2", typ. U.N.O. color Clear anodized 8.33 Alum. storefront 4 1/2" x 4 1/2", color Clear anodized 8.34 Brake mtl. alum., finish to match storefront system 8.35 Alum storefront post, size as noted, finish to match storefront 8.47 1" clear insulating glass low E, see elev. notes 8.48 1" clear insulating glass low E, tempered see elev notes. 8.51 Alum. threshold, set in full bed of mastic 9 9.01 5/8" Exterior Grade Gypsum Ceiling Board, paint exposed surfaces 9.02 5/8" MR GWB w/type "C" firecore, paint exposed surfaces U.N.O. 9.03 5/8" GWB, paint exposed surfaces U.N.O. REV. DESCRIPTION 9.04 5/8" GWB w/type "C" firecore, paint exposed surfaces U.N.O. 9.05 5/8" moisture resistant GWB, paint exposed surfaces 9.06 1-5/8" x 25 ga. mtl. studs at 16" o.c. 9.07 2-1/2" x 25 ga. mtl. studs at 16" o.c. 9.08 3-5/8" x 25 ga. mtl. studs at 16" o.c. 9.10 6" x 25 ga. mtl. studs at 16" o.c. 9.11 3 5/8 " x 20 ga. mtl. studs at 16" o.c.. U.N.O. See struct. for ma 9.12 4" x 20 ga. mtl. studs at 16" o.c., see Struct. for track ga. 9.13 6" x 20 ga. mtl. studs at 16" o.c. See struct. for manuf. 9.14 20 ga clip angle by It. ga supplier, spaced at no greater than 8'vertically and 4'-0" o.c. horizontally See struct. for manuf. 9.15 3-1/2 x 25 ga. mtl. studs at 16" o.c. 9.20 7/8" metal furring channel @ 16" o.c. horiz. 9.21 2' x 4' lay—in accoustical clg. tile. See Finish Schedule. 9.22 2' x 2' lay—in accoustical clg. tile. See Finish Schedule. 9.35 Resilient floor tile DATE 9.36 4" high resilient base 9.51 Paint 05-05-2014 9.52 Semi—transparent stain 9.53 Opaque stain 9.54 Special coating w/ block fill type primer SHEEDINAME 9.55 Match prefinished system 10 10.02 Fabric awning: fabric must be flame resistant, approved class A or class 1 rated by ASTM e-84 **ELEVATIONS** install on 1" sq alum tubing, cap all ends. 10.04 Fire extinguisher, verify final location w/Fire Marshall 10.05 Prefab. signage box; furnished, installed, and connected by Contractor 11 1 11.01 Store fixtures; furnished, installed, and connected bv others 11.02 Store fixtures; furnished and installed by others and connected by Contractor


11.03 Store fixtures; furnished by others and installed and

11.04 Store fixtures; furnished, installed and connected

connected by Contractor

15 15.01 Master water meter, see Plumbing dwgs.

**KEYED NOTES:** 

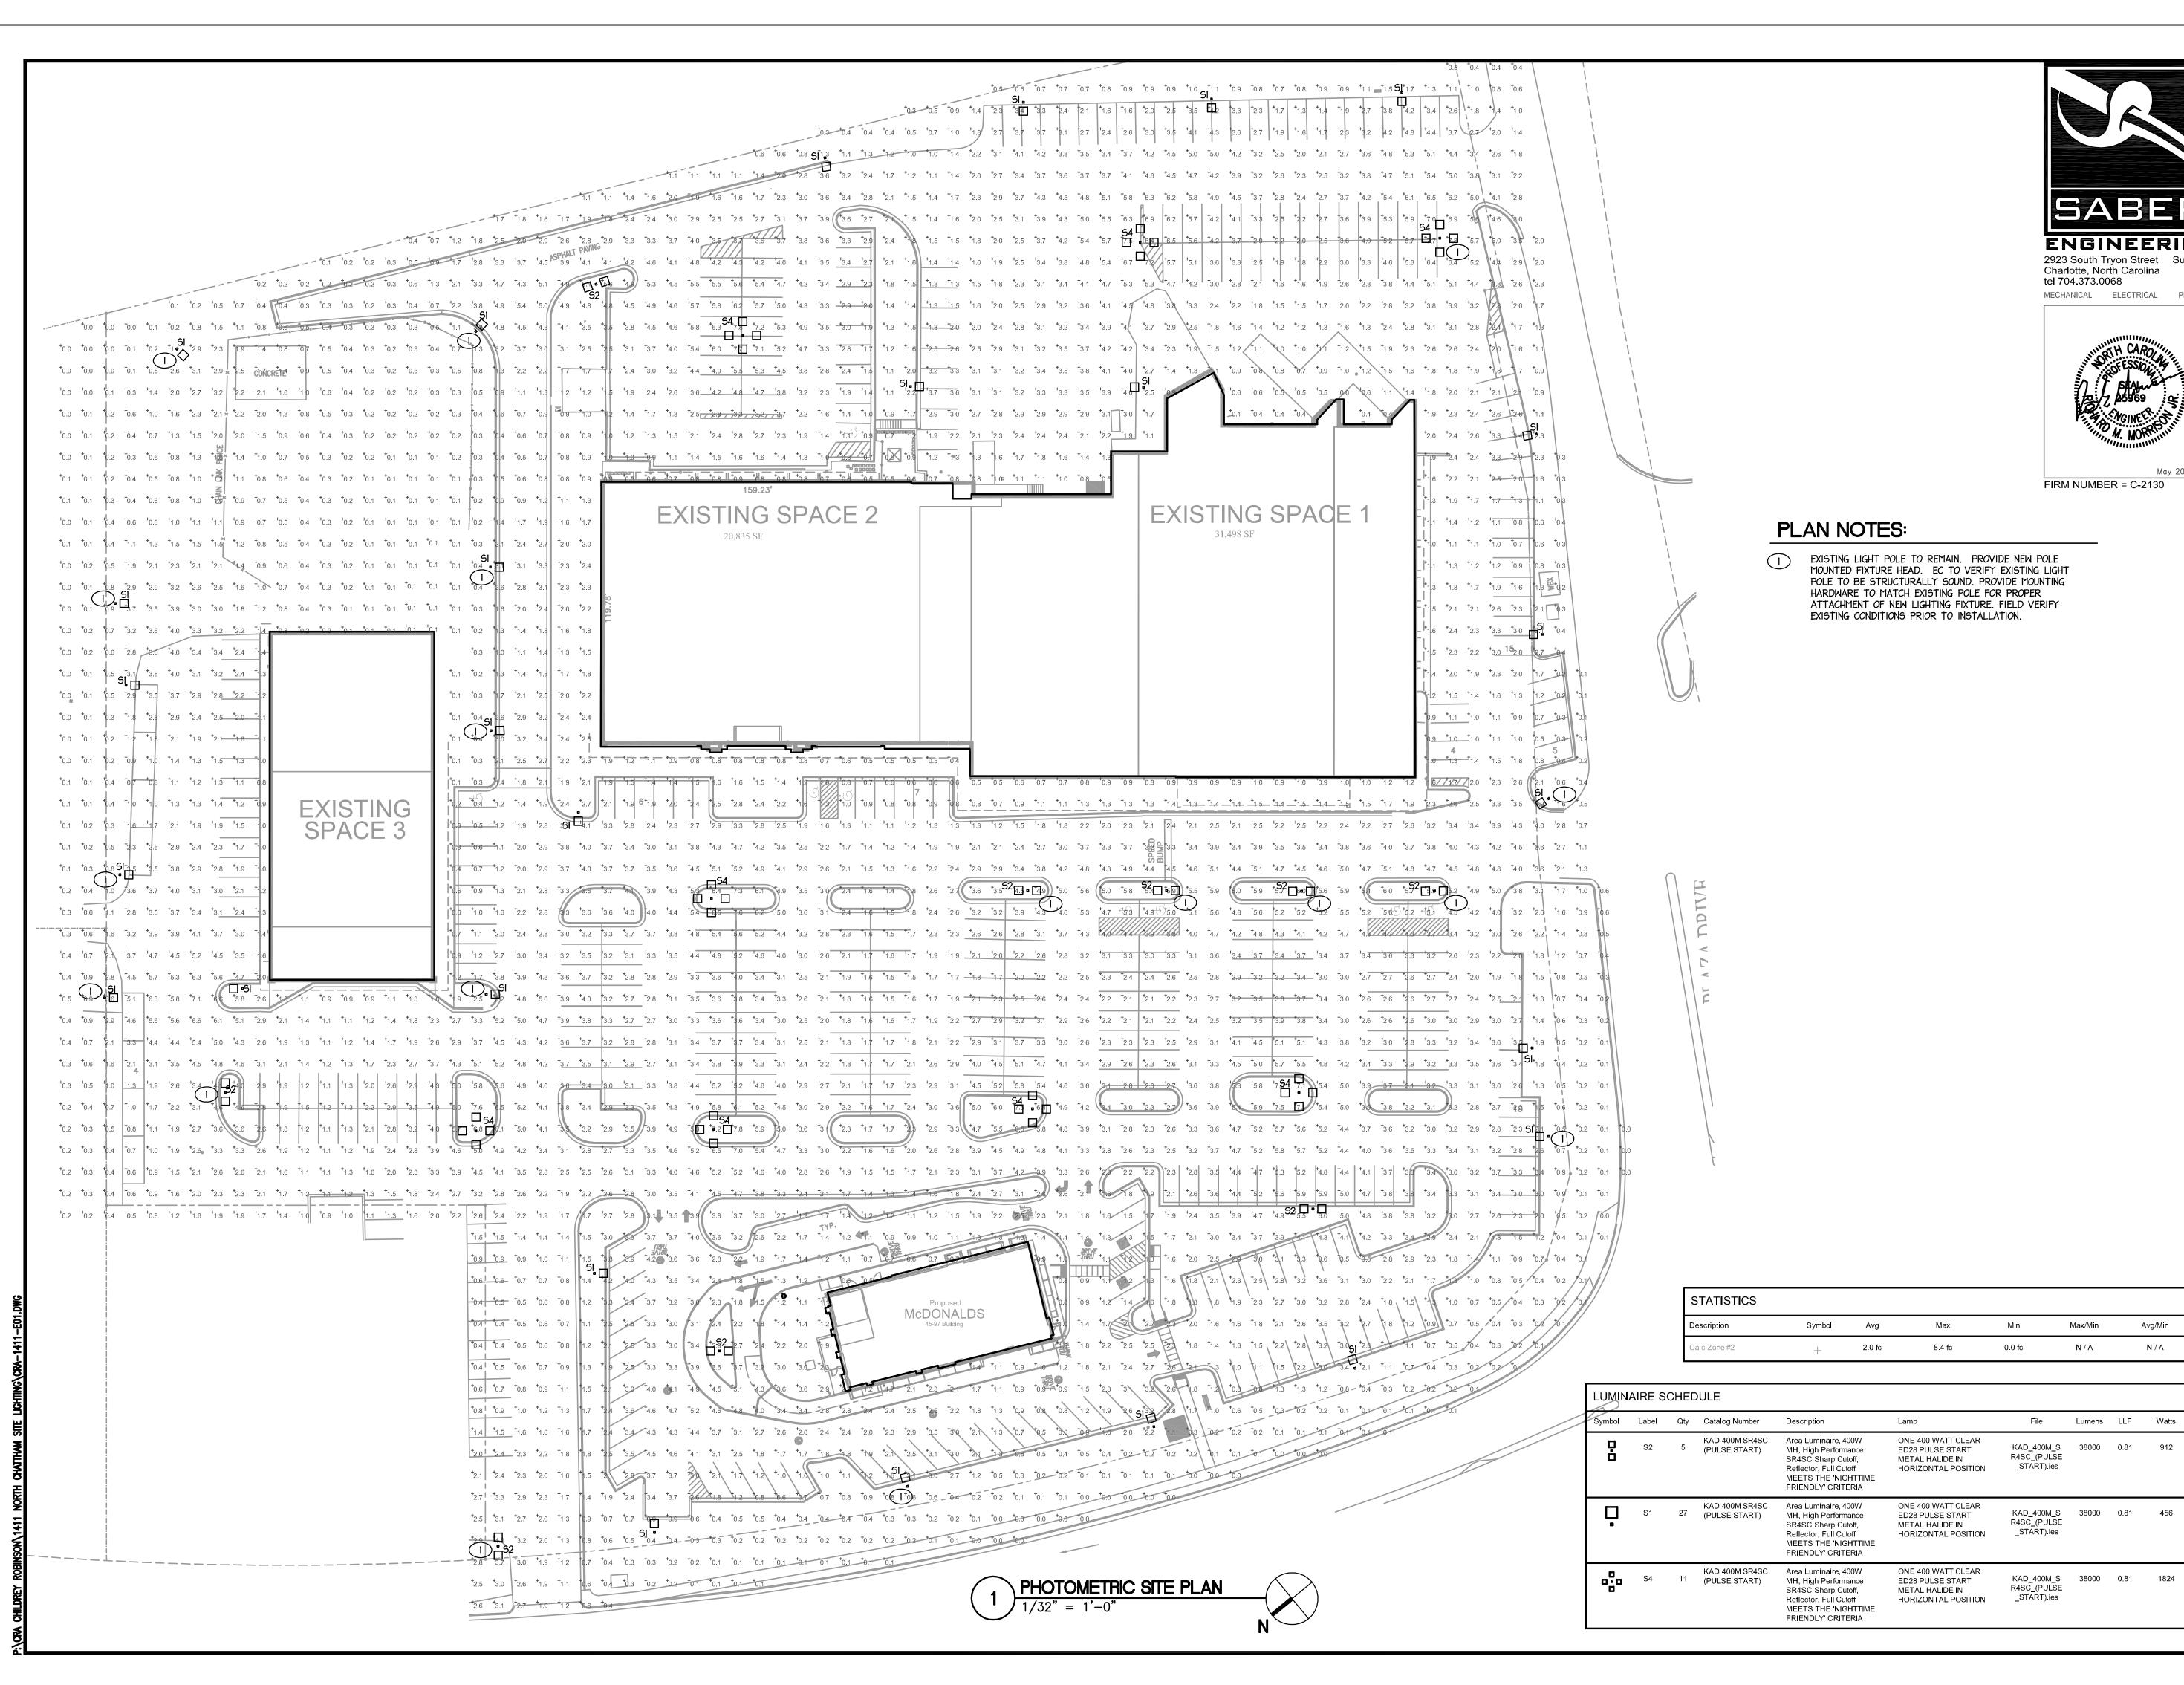

SABE ENGINEERING


2923 South Tryon Street Suite 280 Charlotte, North Carolina 28203 tel 704.373.0068 MECHANICAL ELECTRICAL



Written dimensions take precedence over scaled dimensions.

05-14-2014

PLAN AND FIXTURE LAYOUT

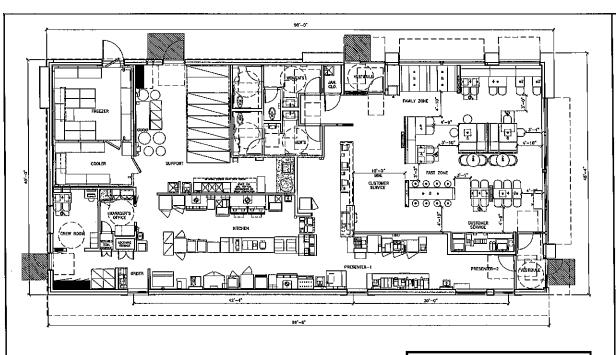

4597-WW PLAN 66 SEATS (4 ACCESSIBLE SEATS)

THIS DRAWING IS FOR REFERENCE ONLY NOT FOR CONSTRUCTION

#### OCCUPANCY ALLOWANCE:

INTERNATIONAL BUILDING CODE 2012

TABLE 1004.1.1 MAXIMUM FLOOR AREA ALLOWANCES PER OCCUPANT				
FUNCTION OF SPACE	ALLOWANCE	AREA	OCCUPANTS	
ACCESSORY STORAGE AREAS, MECHANICAL EQUIPMENT ROOM	300 GROSS	535 SF	2	
ASSEMBLY WITH FIXED SEATS	SEE PLAN	_	66	
ASSEMBLY W/OUT FIXED SEATS STANDING SPACE	5 NET	98 SF	20	
BUSINESS AREAS	100 GROSS	57 SF	1	
KITCHENS, COMMERCIAL	200 GROSS	_	17	
_	_			
_	-	-	_	
-			-	
=	-	_	_	
-				
TOTAL OCCUPANCY ALLOWANCE			106	

#### 2013 4597-WW BUILDING XXXXXXXXX REGION

#### **BUILDING INFORMATION:**

#### **ADDRESS:**

STATE SITE CODE: XXX-XXXX STREET ADDRESS: XXXXXXXXXXXXXXXX CITY: XXXXXXXXXXXXXX COUNTY: XXXXXXXXXXX STATE: XXXXXXXX

#### **STRUCTURE**;

WOOD LOAD BEARING WALLS, WOOD ROOF FRAMING

#### <u>UTILITIES:</u>

ELECTRIC GRILLS & ELECTRIC FRYERS GAS HVAC & GAS WATER HEATER

#### **BUILDING CODE:**

FUEL/GAS CODE EDITION: HEALTH CODE EDITION: ACCESSIBILITY CODE EDITION:

BUILDING CODE EDITION: INTERNATIONAL BUILDING CODE 2012
MECHANICAL CODE EDITION: INTERNATIONAL MECHANICAL CODE 2012
ELECTRICAL CODE EDITION: INTERNATIONAL ELECTRICAL CODE 2011
ENERGY CODE EDITION: INTERNATIONAL PLUMBING CODE 2012
FIRE/LIFE SAFETY CODE EDITION: INTERNATIONAL ENERGY CODE 2012
FIRE/LIFE SAFETY CODE EDITION: INTERNATIONAL FIRE CODE 2012

INTERNATIONAL FIRE CODE 2012 INTERNATIONAL FUEL GAS CODE 2012 XXXXXXXXXXX HEALTH CODE ANSI 117.1 2009

#### **BUILDING DATA:**

OCCUPANCY: USE GROUP A2 CONSTRUCTION TYPE: VB NUMBER OF STORIES: 1 BUILDING HEIGHT: 18'-9 1/2" (MAIN BLDG, PARAPET)

GROSS BUILDING AREA: 4,393 GROSS S.F. BASE BUILDING: 4,059 NET S.F.

#### **DESIGN LOADS:**

GROUND SNOW LOAD: WIND SPEED: SEISMIC DESIGN CATEGORY; SOIL BEARING CAPACITIES: .xx PSF xx MPH (EXPOSURE X) 1500 PSF (ASSUMED)

#### LIFE SAFFTY SYSTEM.

v YFS	NO
X YES	МО
YES	_X_ NO
	NO
	No
	NO
	No
<u>X</u> YES	NO
	X YES X YES X YES X YES X YES X YES X YES X YES

#### DESIGNER OF RECORD:


DISCIPLINE:	NAME:	ADDRESS	LICENSE
ARCHITECT:	XXXXXXXXX	XXXXXXXXXXXXXXXXXXXXX	ххххх
STRUCTURAL:	XXXXXXXXX	XXXXXXXXXXXXXXXXXXXXX	XXXXX
MECHANICAL:	XXXXXXXXX	XXXXXXXXXXXXXXXXXXX	XXXXX
PLUMBING:	XXXXXXXXX	XXXXXXXXXXXXXXXXXXXXX	XXXXX
ELECTRICAL:	XXXXXXXXX	XXXXXXXXXXXXXXXXXXX	xxxxx

#### CONSTRUCTION PROJECT MANAGER:


	NAME:	ADDRESS	PHONE #:
MANAGER:	XXXXXXXX	XXXXXXXXXXXXXXXXXXXXXXXXXXXXXXXXXXXXXXX	XXXXXXXXXXXXXXX


		Т	1 1	TT	777
REVISIONS	DRAWING INDEX		Н	++	鱼
	T1.0 Cover Sheet	Ιĺ	Ш	11	111
	DRIVE-THRU (FOR REFERENCE ONLY)		$  \  $	11	
	DT1.0 Drive-Thru Plan & Details		11		111
	ARCHITECTURAL			11	
	A1.0 Floor Plan		Н		z
	A1,2 Reflected Ceiling Plan		Н		DESCRIPTION
	A1.3 Roof Plan A2.0 Elevations	Ш	Ш	11	SCR
	A2.1 Elevations	П	11		8
	A4.0 Enlarged Restroom Plan & Details	Н	H		111
<del>                                     </del>	A4.1 Enlarged Plan Details	<b>!</b>	$  \  $	11	
	A5.0 Wall Sections & Details A5.1 Wall Sections & Details	П		11	
	A5.2 Wall Sections & Details	Ш	Ш	11	
	A5.3 Wall Sections & Details	Н	Ш	11	1
┠┈╁┈╁┈╂┈┞┈	A6.0 Door & Hardware Schedules	+	╫	++	+
	A6.1 Finish Schedules	П		$\ \cdot\ $	DATE
	STRUCTURAL	$\sqcup$	$\sqcup$	$\perp \downarrow \downarrow$	
	S1.0 Foundation Plan	П			쭚
<del></del>	S1.2 Roof Froming Plan	H	Щ.		- L
	S2.0 Foundation Sections S2.1 Foundation Details	ł			
<del>                                     </del>	S3.0 Framing Sections				
	S3.1 Framing Sections	ŀ			
	S3.2 Framing Details	ı			
	S4.0 General Notes	Į.			
s Brances	MECHANICAL				
	M1.0 Mechanical Roof Plan				
1-1-1-	M1.2 Ductwork Plan				
<del>    - - - -</del>	M1.4 Refrigerant & Gas Piping Plan M2.0 Exhaust Hoods				
	M3.0 Mechanical Details	l			
	M4.0 General Mechanical Notes	1			
	M4.1 Mechanical Schedules	1			
	FIRE PROTECTION	ä			
	FIRE PROTECTION PLAN — Provided by Others	PREPARED			
	PLUMBING			-	
	P1.0 Domestic Water Piping P1.2 Waste Vent & Storm Piping Plan	3		4 de 66	1887 1864
	P1.2 Waste Vent & Storm Piping Plan P1.4 Underground Rough—in	S.	ָ ר	or of the	equit equit
	P1.6 Overhead Rough—in	\$2013 McDonald's USA, LLC	ָּ ב	1 2 2	let. Repro
	P2.0 Domestic Water Isometric	4сОог	, T	transier issue	₽ 5.44 E 5.44
	P2.1 Waste & Vent Isometric	12.	A SO	2 a a	a let nother gines projek
	P2.2 Storm Isometric P3.0 Details		<b>5</b>	돌살	5 5 5 5 5 6 5 5 5 6 7 5
	P4.0 General Notes		(I)	. " 5 5	tage -
	P4.1 Schedules		0	LLC and The co	fferent sil or exem orchitects reuse on
t Expedition	ELECTRICAL	1	McDonald	ž 13 7	
	E1.0 POS Electrical Riser Diagram		ō	SUS (zeftos)	on a eferen license rts fo
	E1.1 Rough In Floor Plan	1		and specification.  butharization.  specific site	inge ingre
	E2.0 Lighting Plan & Schedule	é	5	These drawnigs and property of McDandl without written author for use on this spe	age to
	E2,1 Electrical Roof Plan E3.0 Electrical Schedule	ē.		2 2 2 2 2 2 2 2 2 2 2 2 2 2 2 2 2 2 2	itable gravi ntroc
	E3.1 Electrical & Lighting Notes	EPARE	$\equiv$	mese di property sithout	oot suit these d services the con
	E4.0 Wiring Details	R.	_		್≎ಕ್
	E4.1 Lighting Controls	ķ	DATE	8	<u>a</u> &
	E4.2 Utilities Distribution	DRAWN BY	383E	REVIEWED	20 X
	KITCHEN EQUIPMENT	ĕ	STD ISSUE DATE	Æ	DATE ISSUED MM DD YYYY

#### SYMBOL LEGEND:

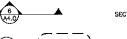

ROOM NAME & NUMBER

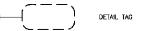

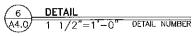



ELEVATION TAG

PARTITION TAG

K1.0 Kitchen Cover Sheet K2.0 Kitchen Equipment Plan

K2.1 Kitchen Equipment Schedule

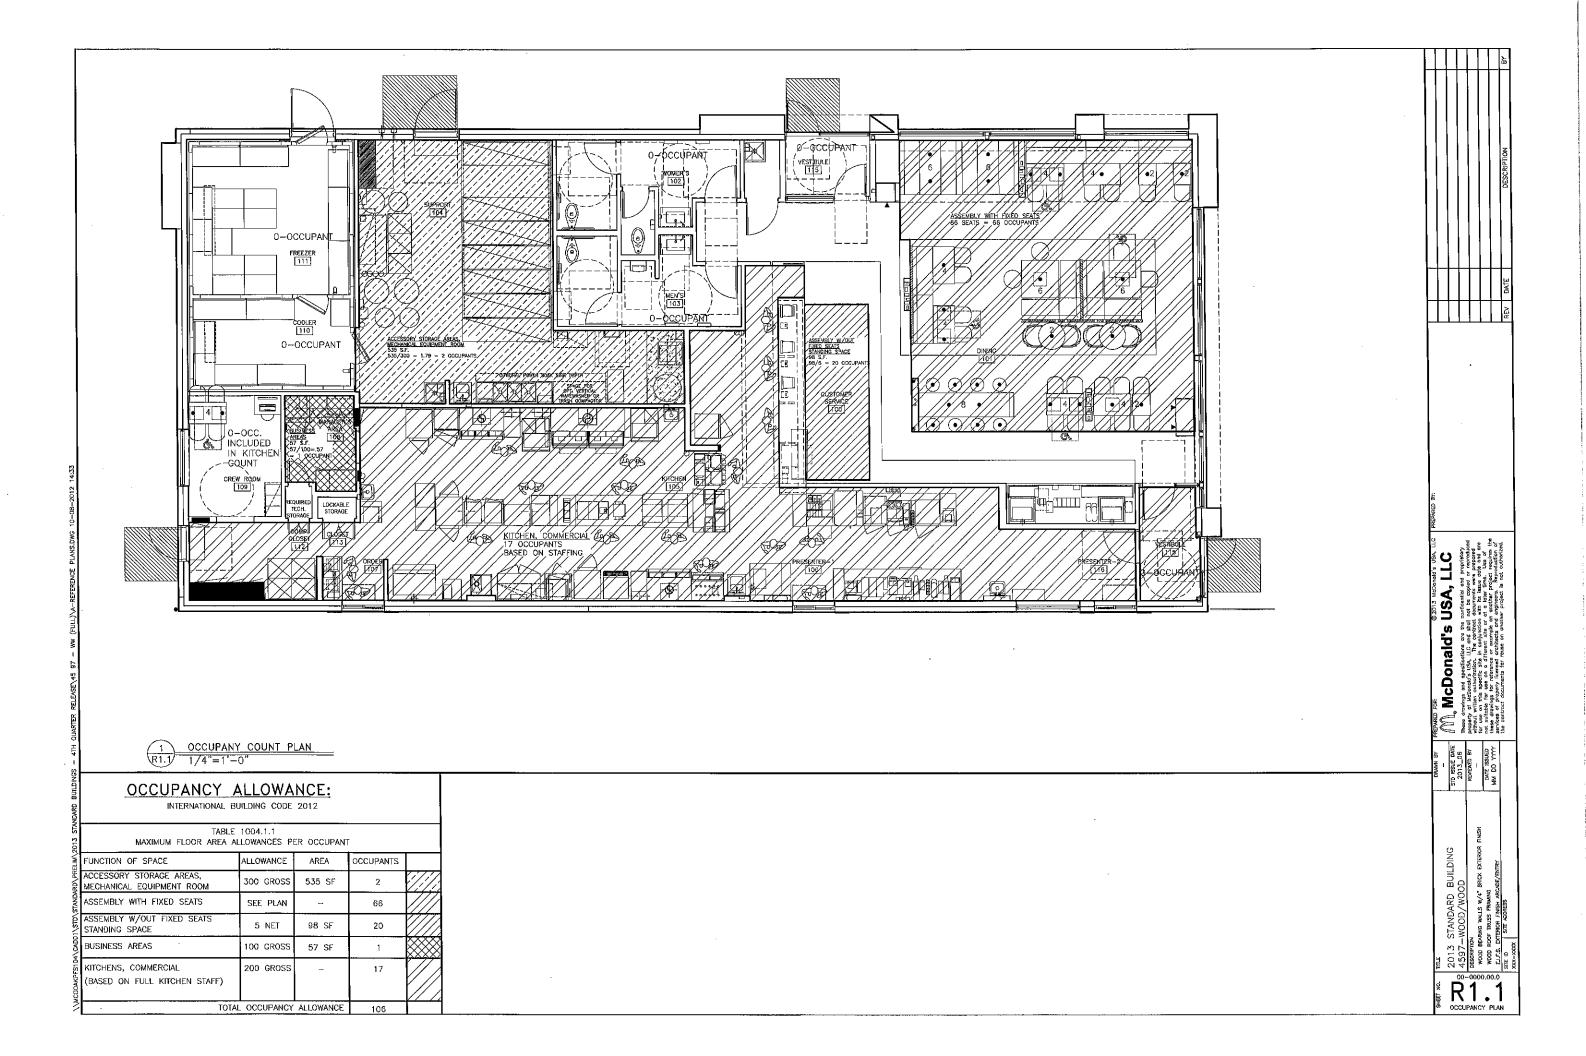


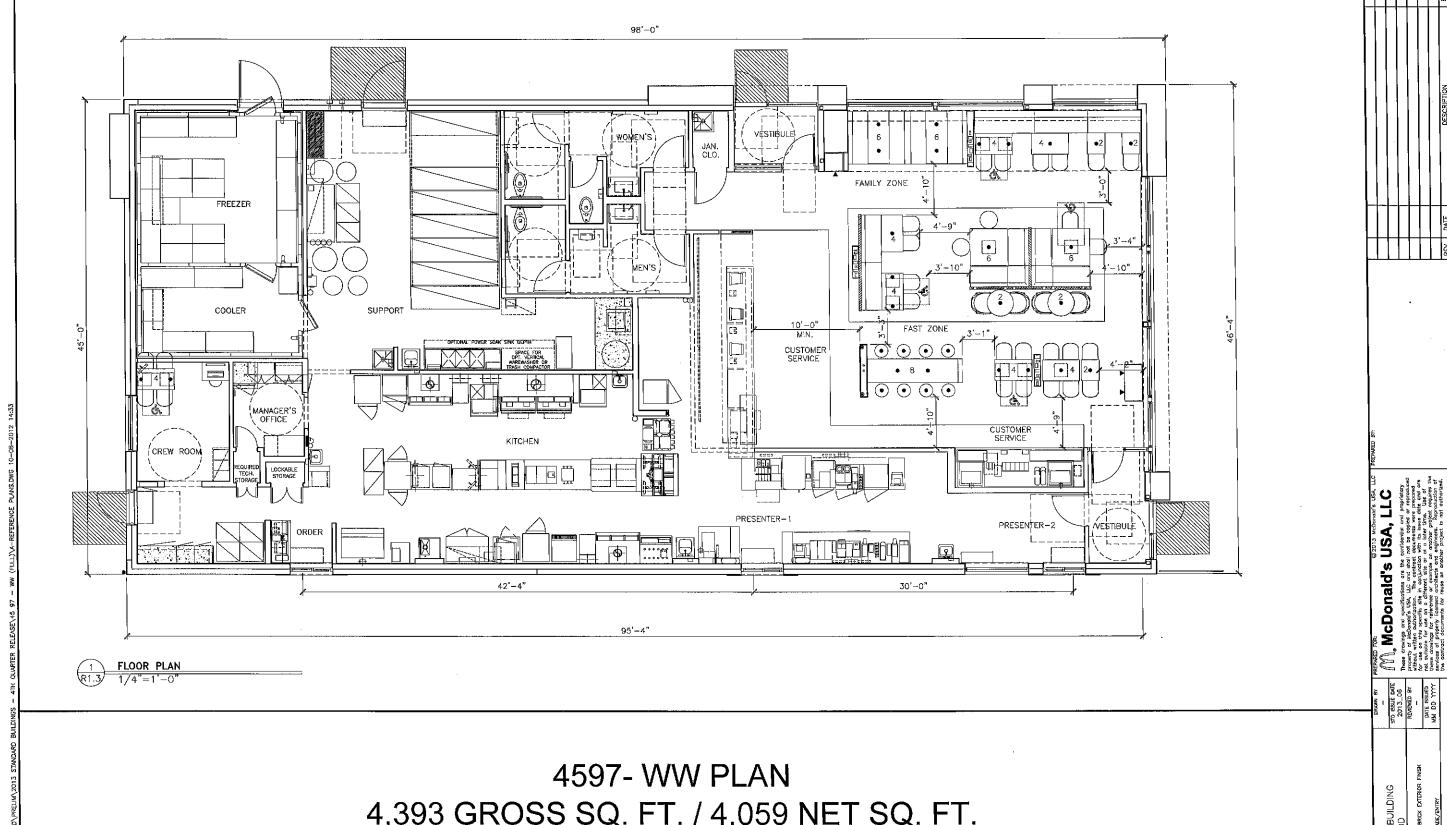



4,393 GROSS SQ. FT. / 4,059 NET SQ. FT. 66 SEATS (4 ACCESSIBLE SEATS)

TOTAL BUILDING SIGNAGE: 138.5 SF


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Please sign & return drawing/s to FASTSIGNS
OR AGENT
SIGNATURE
HERE

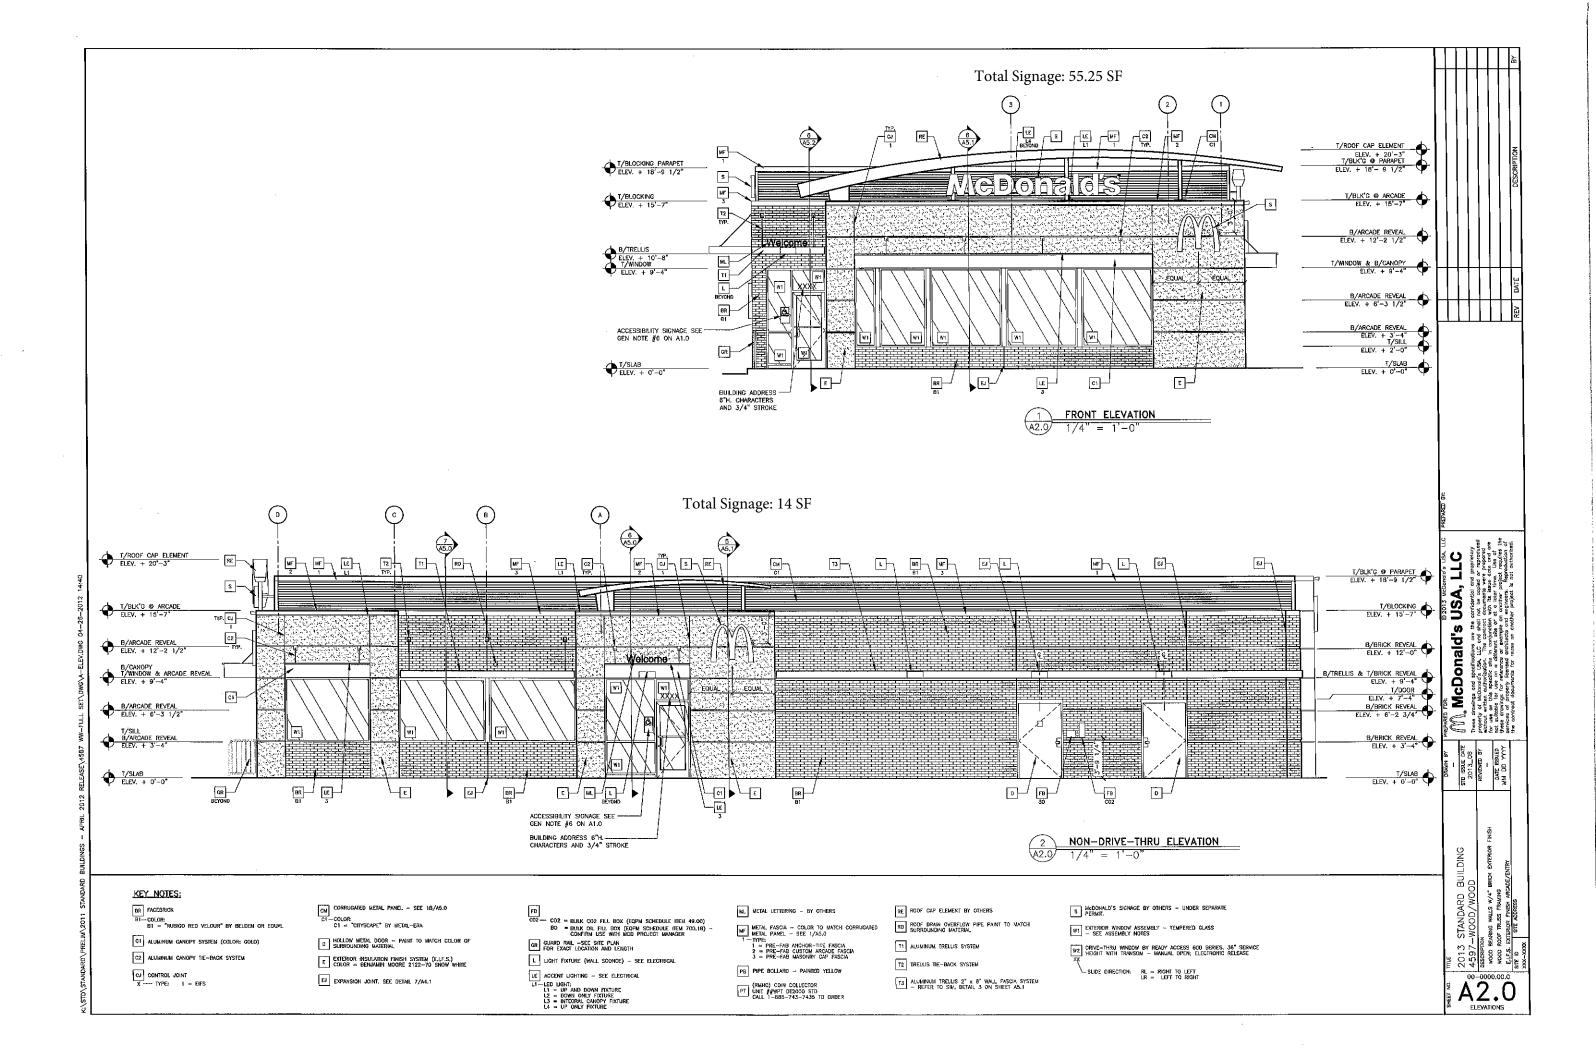Please sign & return drawing/s to FASTSIGNS
Signature below indicates approval of BOTH design & placement of sign/s

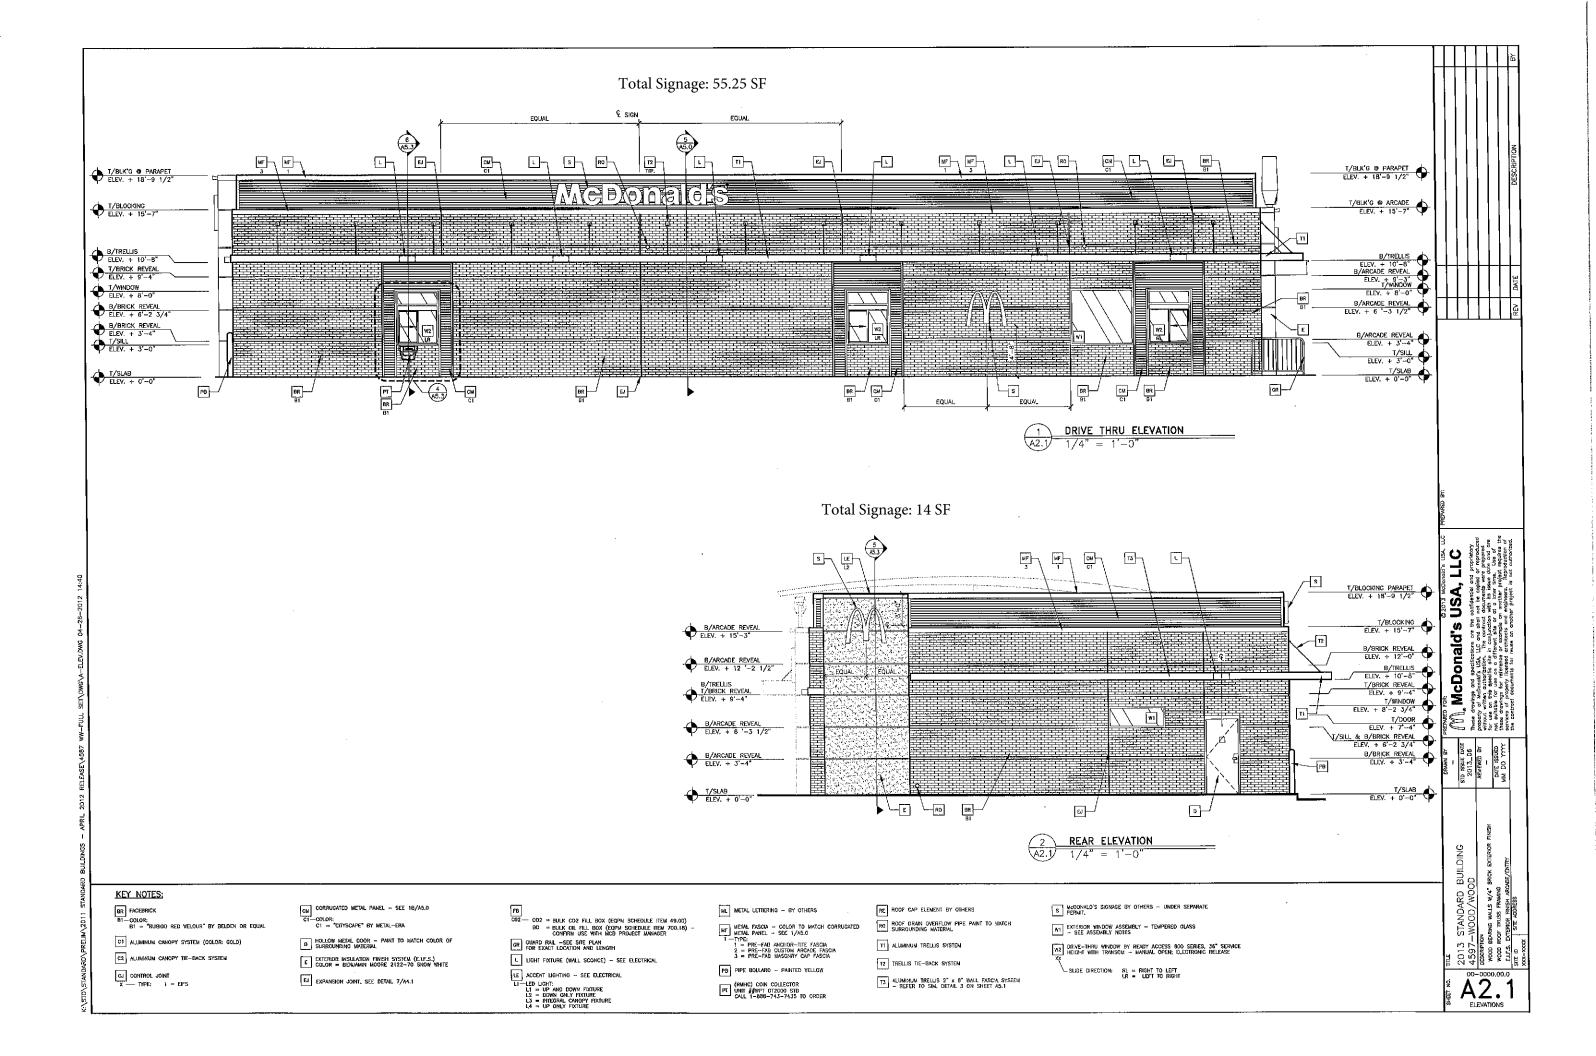DATE
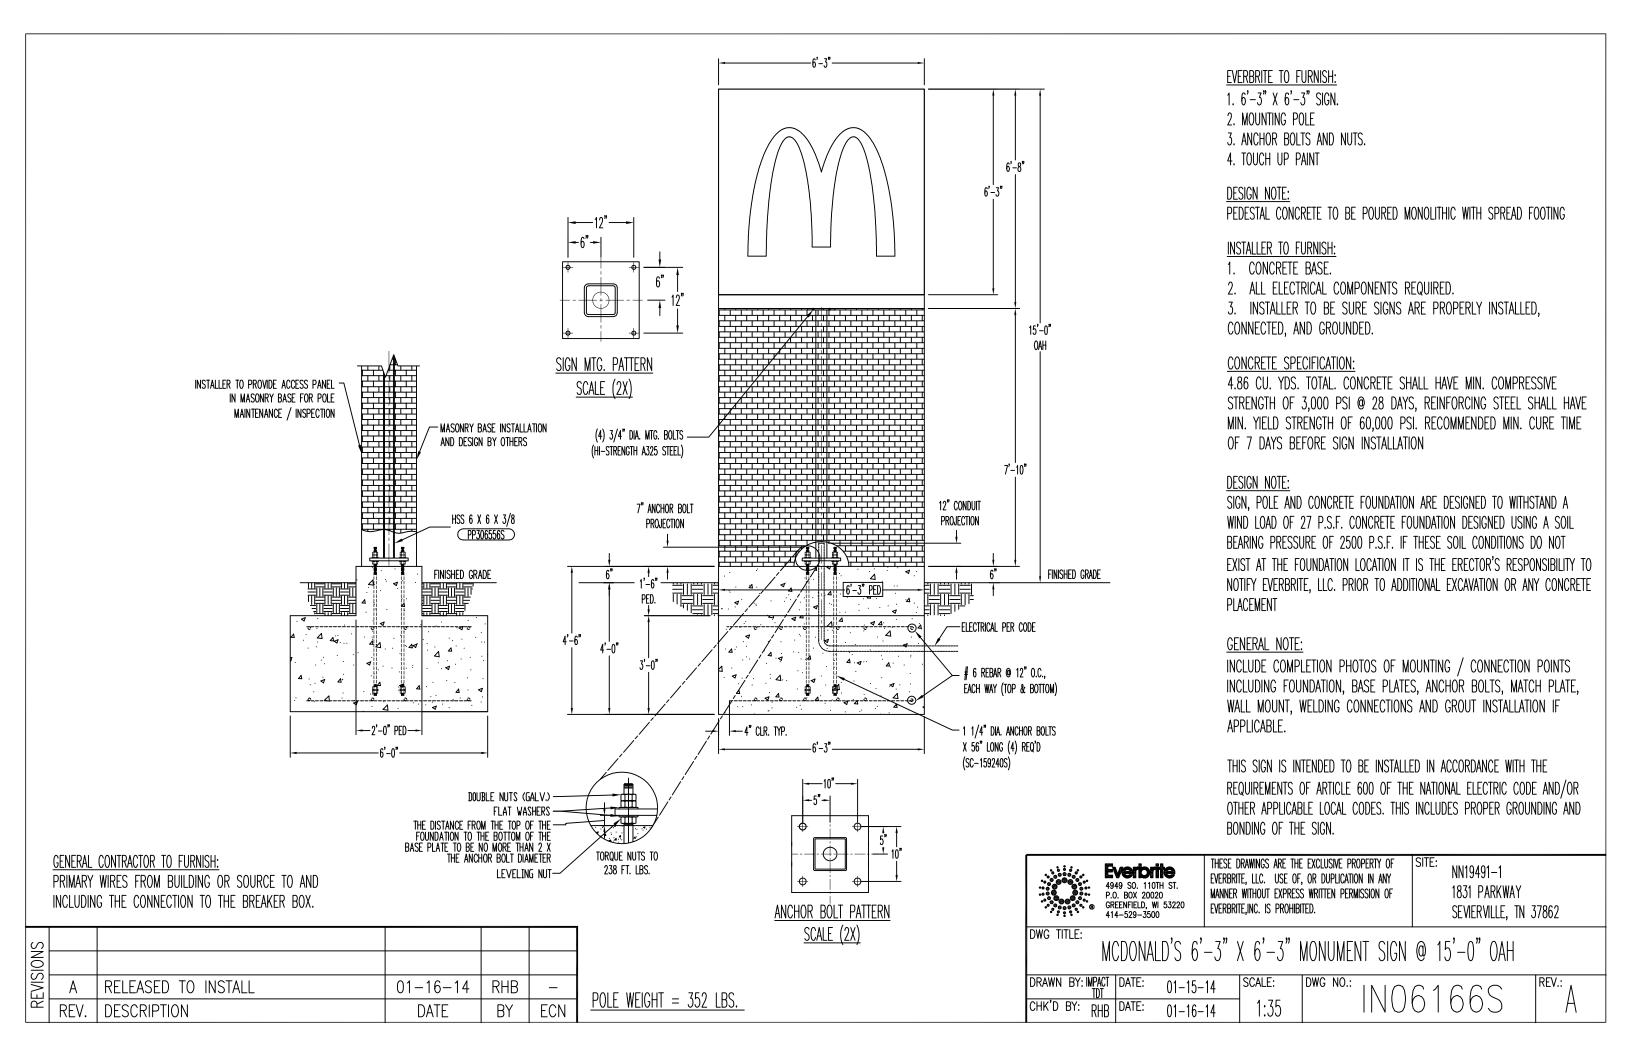
### \*DRAWING IS NOT TO SCALE BUT IS PROPORTIONATE\*

FIELD VERIFY ALL MEASUREMENTS BEFORE BEGINNING ANY WORK. INSTALLER TO VERIFY MOUNTING SURFACE PRIOR TO INSTALLATION.
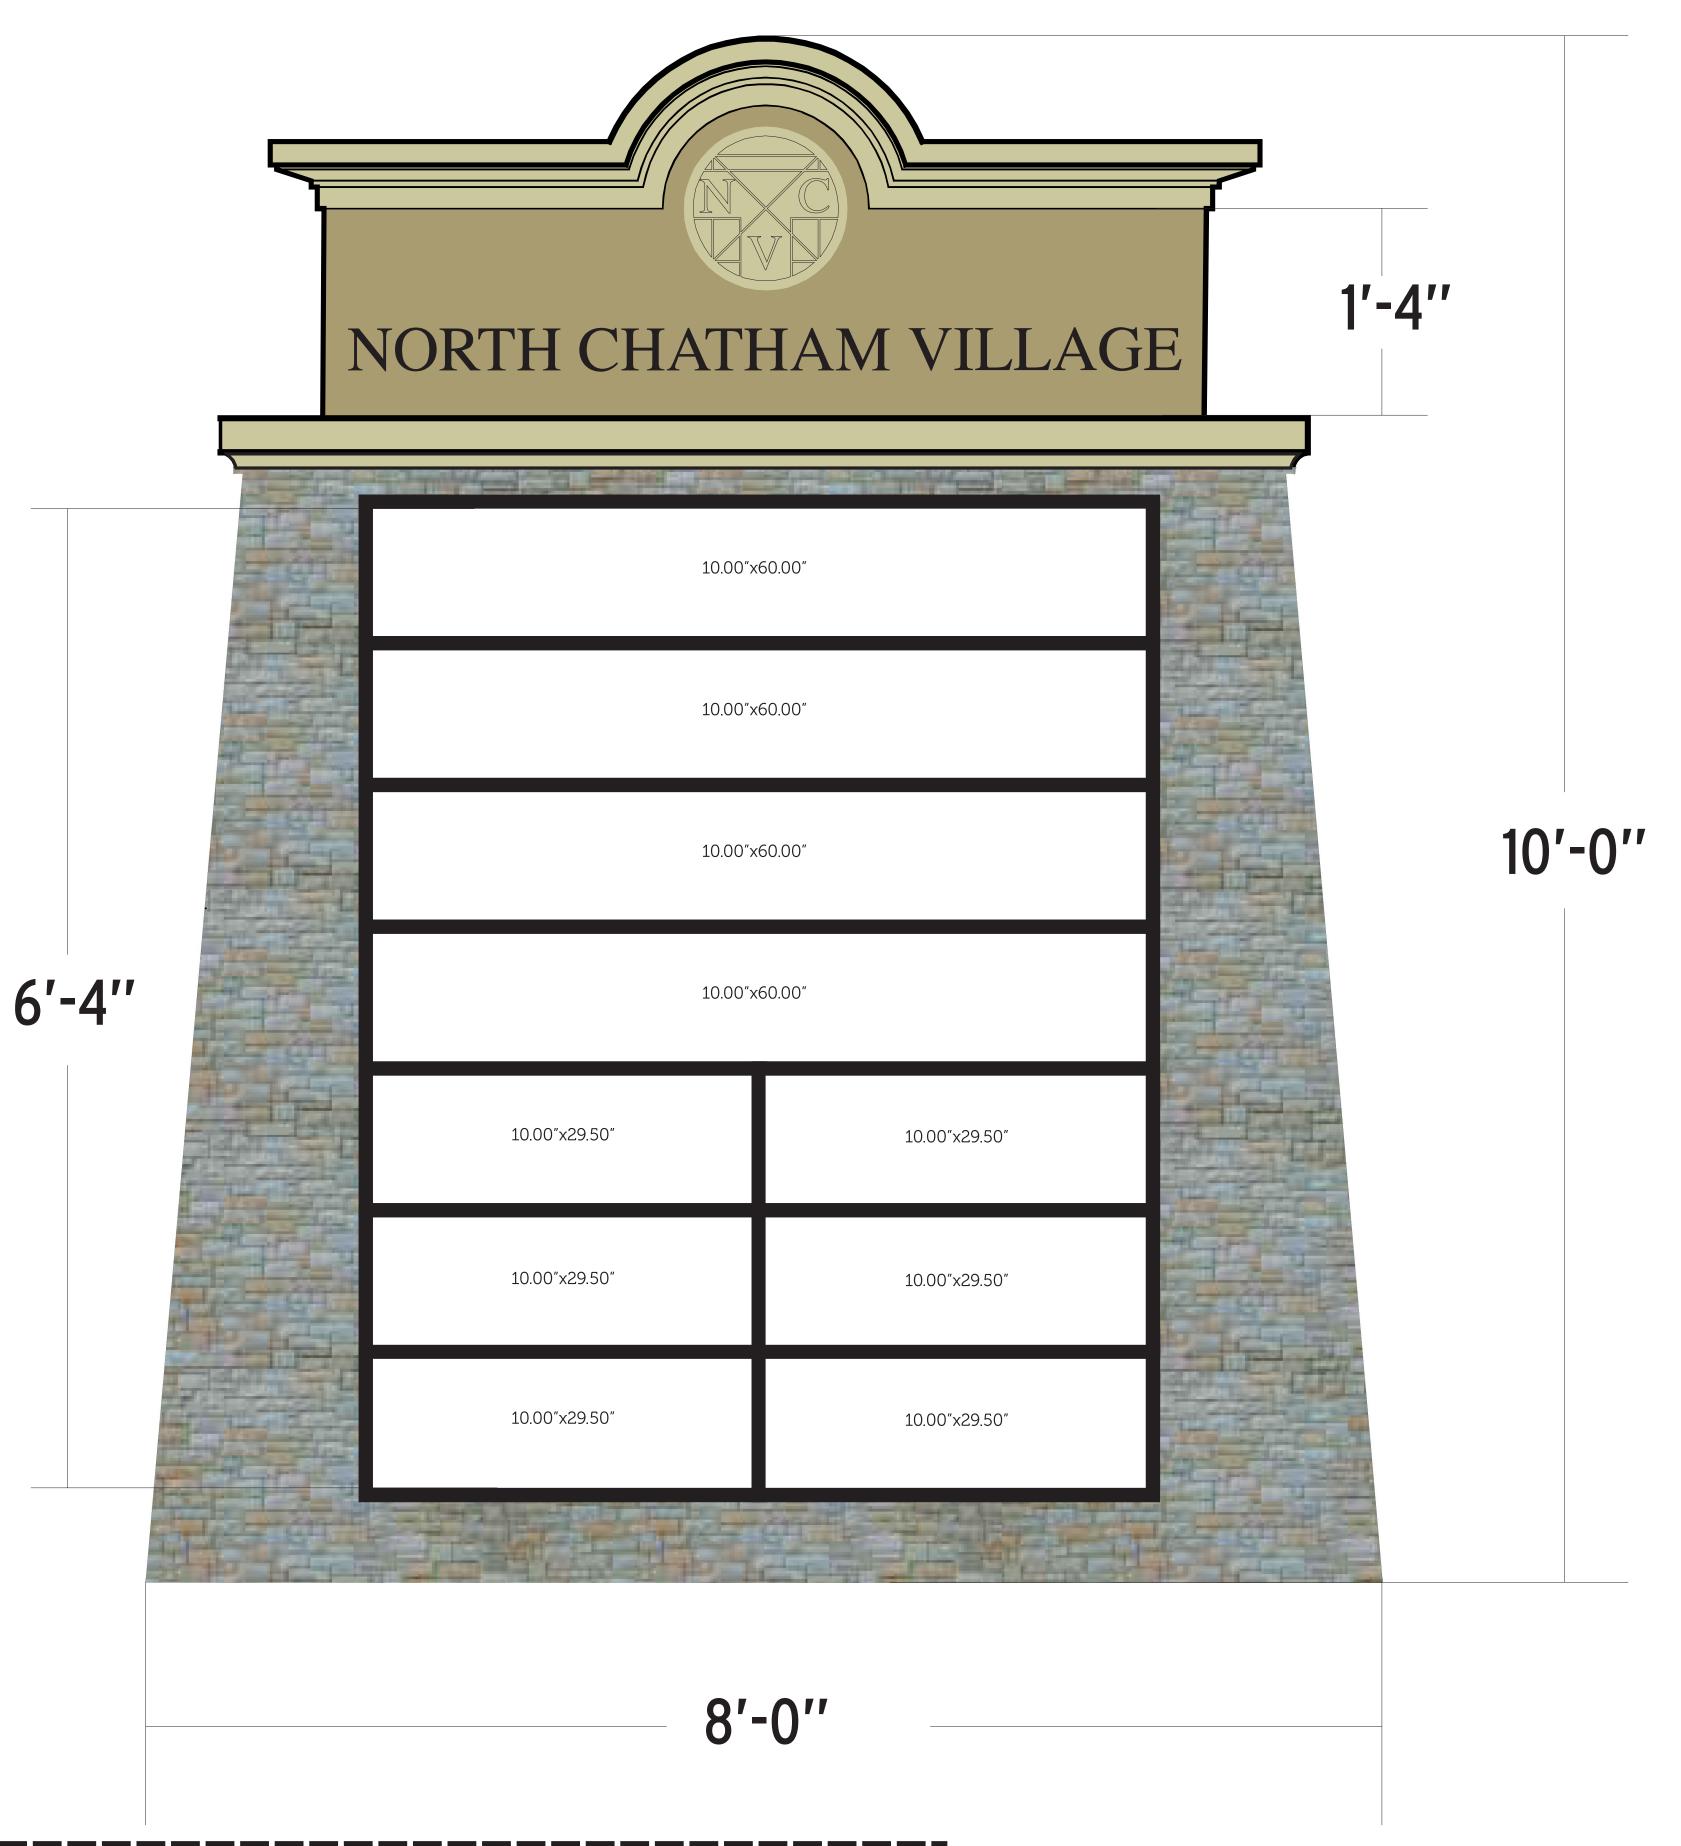
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FS Sout	h Tryon	
E: ChathamCounty_10'tall.ai May 2014 REPRESENTATIVE:		
B. Knight  ADDRESS:		
	ATE 06 02 2014	
	ATE: 06-02-2014	
DRAWING NUMBER:  1 of 1	SCALE: NTS	
REV. #1 BY:	REV. DATE	
PEVISION NOTES:		
REV. #2 BY:	REV. DATE	
PEVISION NOTES:		
REV. #3 BY:	REV. DATE	
PEVISION NOTES:		
IOTES:		
AWN BY: BRANDON GOODSON		
VISED BY:		
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