

### NOTES:

- 1. This plan was prepared without the benefit of a report of title.
- 2. This plan does not represent a title survey.
- 3. The basis of the bearings and coordinates. for this plan is the North Carolina State Plane Coordinate System, North American Datum (NCSPCS/NAD 83) based on differential GPS observations performed on April 23, 2013 and tied to the National CORS system via the OPUS utility and expressed in US Survey Feet.
- 4. Vertical information shown, based on the North American Vertical Datum of 1988 (NAVD '88) in US Survey Feet.
- 5. Property lines are drawn from information found in Deed Book 1437, Page 670, of the Chatham County Register of Deeds records.
- 6. All distances are ground unless otherwise noted.
- 7. This property is located in flood zone "X", areas determined to be outside 0.2% chance of annual flood. (FEMA Community Panel # 3710976600J. effective February 2, 2007).
- 8. Lessee Information: American Tower Corporation 400 Regency Forest Drive Cary, NC 27511
- 9. Property Information: James & Jane Womble 189 Cestnut Way Chapel Hill, NC 27516

### 1A CERTIFICATE

LATITUDE: N 35° 51' 28.053" (NAD ' 27) LONGITUDE: W 79° 07' 22.358" (NAD ' 27)

LATITUDE: N 35° 51' 28.572" (NAD '83) LONGITUDE: W 79° 07' 21.404" (NAD '83)

GROUND ELEV. (AMSL): 580.1'± (NAVD '88)

### ADJOINER INFO: **BUILDING SETBACKS**

BUILDING SETBACKS ARE FOR PARCEL (ZONED R2), PER CHATHAM COUNTY PLANNING

100'

50'

50'

SHARON MCCOY

PIN# 87588

DB 1437 PG 216

& LYNN DAVIS

PIN# 2539

(919) 542-8204 STREET YARD: SIDE YARD REAR YARD

PUBLIC ,

DB 952 PC 630

.09

PO

L12-

L11-

N/F VICKY & JOHN BACHMANN PIN# 73597 \DB 826 PG 1057

2. N/F JAMES & LOLA WOMBLE PIN# 2164 DB 357 PG 81 KAREN BRUSCHKE & MICHAEL WOMBLE DB 1493 PG 1061

7. N/F SUZANNE HILL

N/F JAMES & JANE WOMBLE PIN# 79653 DB 928 PG 16

N/F TODD & TAMARA MEATH PIN# 69634 DB 671 PG 1068

N/F COLEEN BREWER PIN# 2163 DB 1423 PG 520

N/F KAYE & JOHN MANN PIN# 2535

N/F JOHN & ALLISON CARTER PIN# 69630 DB 1522 PG 872

DANIEL & JENNIFER GARDNER PIN# 59531 DB 1069 PG 1089

N/F STEVEN WOMBLE & SHARON MCCOY

LINE TABLE

BEARING

S87"12"18"E

587'12'18"E

587'12'18"E

577°02'37"E

S04'28'17"E

PROJECT INFORMATION:

PREPARED FOR:

### AT&T SITE # 368-545 ATC SITE # 280373 MEACHAM NC

MERICAN TOWER

CORPORATION

400 REGENCY FOREST DR.

CARY, NC 27511


POYTHRESS ROAD CHAPEL HILL, NC 27516 (CHATHAM COUNTY)

PREPARED BY:

### TOWER ENGINEERING PROFESSIONALS 3703 JUNCTION BOULEVARD RALEIGH, NC 27603-5263 — (919) 661-6351 NC LICENSE NO. C-1794

### SURVEYOR CERTIFICATE

, CLIFFORD BYRD, CERTIFY THIS PLAT WAS DRAWN UNDER MY SUPERVISION FROM AN ACTUAL SURVEY BY ME OR UNDER MY DIRECT SUPERVISION, (DEED DESCRIPTION RECORDED IN BOOK AND PAGE AS REFERENCED HEREON); THAT THE BOUNDARIES NOT SURVEYED ARE CLEARLY INDICATED AS BROKEN LINES, DRAWN FROM INFORMATION FOUND IN BOOK AND PAGE AS REFERENCED HEREON: THAT RATIO OF PRECISION AS CALCULATED IS 1: 10,000 OR GREATER: THAT THE AREA IS COMPUTED BY COORDINATE METHOD; THAT THIS PLAT WAS PREPARED IN ACCORDANCE WITH G.S.47-30 AS AMENDED. WITNESS MY ORIGINAL SIGNATURE, REGISTRATION NUMBER AND SEAL, THIS 23 DAY OF MAY, 2013.

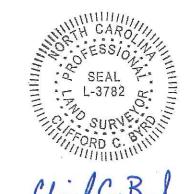

NORTH CAROLINA PLS # L-3782 CLIFFORD C. BYRD

SHEET TITLE:

SITE SURVEY

DATE:	05/23/2013	REVISION: 0
SHEET	#: 1 OF 2	TEP #: 13150



N89°20'04"E 527.60 (1) (2) "YTHRESS RD. (10) N/F RAY WOMBLE

JAMES WOMBLE JANE WALTER PARCEL ID# 85601 DB 1437 PG 670 N/F JOHN HERRICK +/-83.751 ACRES (CALCULATED) NO ZONING DB 778 PG 542

N89'40'52"W S89°30'29"W 1226.68 1189,57 N/F SCOTT MARTIN N/F JANET & CHRISTOPHER VICKERS PIN# 2225 DB 1235 PG 001

N/F HARLON & VICKY HILTON DB 515 PG 711

CONVERGENCE ANGLE -0'04'14.77" ( IRF ( (CALCULATED) EDGE OF PAVEMENT DECLINATION ---OHW--- OVERHEAD WIRE ---R/W--- RIGHT-OF-WAY

400

SITE SURVEY

SCALE: 1" = 400'

N/F KRISTY RICHARDS PIN# 69632 DB 1341 PG 494

PIN# 69633 DB 1514 PG 808

N/F JOHN COFFEY

&
ARAYA SRICHAIRUT
PIN# 76763
DB 1423 PC 520

849.93

DB 1359 PG 364

L100

(5)

MICHAEL &

N/F JEAN WILLIAMS

PIN# 69652 DB 503 PC 374

N/F JEAN WILLIAMS

PIN# 60539 DB 503 PG 374

9

MAGNETIC

08'48'18"

6

(7)

(3)

L5 177.02 S83'02'29"E L6 12.47 501"19"39"E L7 125.14 S88'38'03"E L8 455.49 S88'38'03"E S87'09'18"E L9 266.74 L10 149.54 589'36'50"E L11 80.59 N07'31'07"E N08'42'34"E L12 95.42 JACQUELINE STOUT L13 N11'49'07"E 95.07 PIN# 69635 DB 646 PG 857 N15\*40'40"E L14 95.02 L15 95.75 N18"06"15"E L16 N18'43'56"E 42.40\* L17 270.04 578'04'28"E

LINE LENGTH

L2

L3

L4

L18

68.21

275.00

30.44

77.26

N03'06'49"W L19 162.30 L20 108.03 N82'54'05"W L21 N77"10"59"W 209.83 L22 357.69 N65'40'01"W N04\*28'57"E L23 18.59"

100.32

LEGEND PROPERTY LINE PROPERTY LINE

(NOT SURVEYED) ADJOINERS PROPERTY LINE (NOT SURVEYED) 0 EXIST. UTILITY POLE

EXIST. TELCO PEDESTAL IRON ROD (FOUND) PROPERTY CORNER

- X --- CHAIN LINK FENCE EXISTING TREE LINE

SCALE IN FEET

### LEGAL DESCRIPTION OF LEASE AREA PARCEL "A"

ALL THAT CERTAIN LEASE AREA PARCEL OF LAND, SITUATE, LYING AND BEING IN CHATHAM COUNTY, NORTH CAROLINA, BEING A PORTION OF THE LANDS DESCRIBED IN DEED BOOK 1437 AT PAGE 670 OF THE CHATHAM COUNTY REGISTER OF DEEDS AND BEING MORE PARTICULARLY DESCRIBED AS FOLLOWS: COMMENCING AT EXISTING IRON AT THE EASTERN RIGHT OF WAY OF POYTHRESS RD., SAID IRON BEING LOCATED AT THE WESTERN LIMITS OF THE PARCEL DESCRIBED IN DEED BOOK 1437 AT PAGE 670, SAID IRON HAVING NORTH CAROLINA STATE PLANE COORDINATES OF NORTHING = 767,243.19', AND EASTING = 1.963.540.95': THENCE FROM THE POINT OF COMMENCEMENT, NORTH 77'31'30" EAST, A DISTANCE OF 78.43 FT. TO A POINT ON THE NORTHWEST CORNER OF THE DESCRIBED 100' X 100' LEASE AREA, SAID POINT BEING THE TRUE POINT OF BEGINNING, AND HAVING NORTH CAROLINA STATE PLANE COORDINATES OF NORTHING = 767,260.13', AND EASTING = 1,963,617.52'; THENCE FROM THE POINT OF BEGINNING SOUTH 87'31'47" EAST, A DISTANCE OF 100.00 FT. TO A POINT: THENCE SOUTH 02'28'13" WEST FOR A DISTANCE OF 100.00 FT. TO A POINT; THENCE NORTH 87'31'47" WEST FOR A DISTANCE OF 100.00 FT. TO A POINT. THENCE NORTH 02'28'13" EAST FOR A DISTANCE OF 100.00 FT. TO THE POINT OF BEGINNING. SAID LEASE AREA CONTAINING 10,000 SQ, FT. OR 0.23 ACRES MORE OR LESS.

# LEGAL DESCRIPTION OF 30' ACCESS AND


### UTILITY EASEMENT PARCEL "B"

ALL THAT CERTAIN EASEMENT AREA PARCEL OF LAND, SITUATE, LYING AND BEING IN CHATHAM COUNTY, NORTH CAROLINA, BEING A PORTION OF THE LANDS DESCRIBED IN DEED BOOK 1437 AT PAGE 670 OF THE CHATHAM COUNTY REGISTER OF DEEDS AND BEING MORE PARTICULARLY DESCRIBED AS FOLLOWS:

COMMENCING AT EXISTING IRON AT THE EASTERN RIGHT OF WAY OF POYTHRESS RD., SAID IRON BEING LOCATED AT THE WESTERN LIMITS OF THE PARCEL DESCRIBED IN DEED BOOK 1437 AT PAGE 670, SAID IRON HAVING NORTH CAROLINA STATE PLANE COORDINATES OF NORTHING = 767,243.19', AND EASTING = 1,963,540.95'; THENCE FROM THE POINT OF COMMENCEMENT, AND WITH SAID RIGHT OF WAY, SOUTH 19'25'12" WEST A DISTANCE OF 14.88 FT. TO A POINT ON THE EASTERN RIGHT OF WAY OF POYTHRESS ROAD, SAID POINT BEING THE TRUE POINT OF BEGINNING OF A DESCRIBED 30' ACCESS AND UTILITY EASEMENT, AND HAVING NORTH CAROLINA STATE PLANE COORDINATES OF: NORTHING= 767,229.16'; AND EASTING=1,963,536.00'; THENCE FROM THE POINT OF BEGINNING, AND LEAVING SAID RIGHT OF WAY, SOUTH 87'13'36" EAST A DISTANCE OF 80.11 FT. TO A POINT; THENCE SOUTH 02'28'13" WEST A DISTANCE OF 30.00 FT. TO A POINT; THENCE NORTH 87'13'36" WEST A DISTANCE OF 80.32 FT. TO A POINT; THENCE NORTH 02'51'36" EAST A DISTANCE OF 30.00 FT. TO THE POINT OF BEGINNING SAID EASEMENT AREA PARCEL CONTAINING 2406 SQ. FT. OR 0.06 ACRES MORE

L	EGEND
	PROPERTY LINE
-	PROPERTY LINE (NOT SURVEYED)
	ADJOINERS PROPERTY LINE (NOT SURVEYED)
C	EXIST. UTILITY POLE
(I)	EXIST. TELCO PEDESTAL
IRF	IRON ROD (FOUND)
•	PROPERTY CORNER (CALCULATED)
	EDGE OF PAVEMENT
OHW	OVERHEAD WIRE
R/W	RIGHT-OF-WAY
x	CHAIN LINK FENCE
~~~	EXISTING TREE LINE

	LINE TA	BLE
LINE	LENGTH	BEARING
L24	80.11	S87"13'36"E
L25	30.00	S02'28'13"W
L26	80.32	N87'13'36"W
L27	30.00	N02°51'36"E

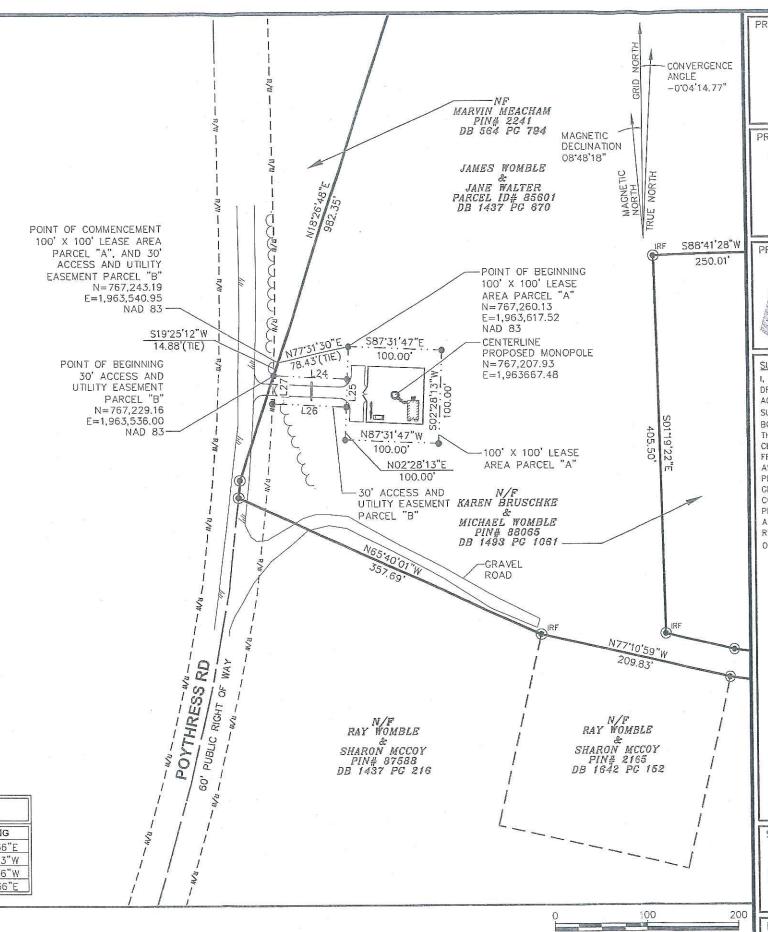

PREPARED FOR:

MERICAN

MERICAN TOWER

CORPORATION

400 REGENCY FOREST DR.

CARY, NC 27511

PROJECT INFORMATION:

### AT&T SITE # 368-545 ATC SITE # 280373 MEACHAM NC

POYTHRESS ROAD CHAPEL HILL, NC 27516 (CHATHAM COUNTY)

PREPARED BY:

TOWER ENGINEERING PROFESSIONALS
3703 JUNCTION BOULEVARD
RALEIGH, NC 27603-5263
(919) 661-6351
NC LICENSE NO. C-1794

#### SURVEYOR CERTIFICATE

I, CLIFFORD BYRD, CERTIFY THIS PLAT WAS DRAWN UNDER MY SUPERVISION FROM AN ACTUAL SURVEY BY ME OR UNDER MY DIRECT SUPERVISION, (DEED DESCRIPTION RECORDED IN BOOK AND PAGE AS REFERENCED HEREON); THAT THE BOUNDARIES NOT SURVEYED ARE CLEARLY INDICATED AS BROKEN LINES, DRAWN FROM INFORMATION FOUND IN BOOK AND PAGE AS REFERENCED HEREON; THAT RATIO OF PRECISION AS CALCULATED IS 1: 10,000 OR GREATER; THAT THE AREA IS COMPUTED BY COORDINATE METHOD; THAT THIS PLAT WAS PREPARED IN ACCORDANCE WITH G.S.47—30 AS AMENDED. WITNESS MY ORIGINAL SIGNATURE, REGISTRATION NUMBER AND SEAL, THIS 23 DAY OF MAY, 2013.



NORTH CAROLINA PLS # L-3782 CLIFFORD C. BYRD

SHEET TITLE:

SCALE IN FEET

LEGAL DESCRIPTIONS

 DATE:
 05/23/2013
 REVISION:
 0

 SHEET #:
 2 OF 2
 TEP #: 131501

**LEGAL DESCRIPTIONS** 

SCALF: 1" = 100'

ATC SITE NUMBER:

280373

ATC SITE NAME:

MEACHAM NC

PROJECT DESCRIPTION:

PROPOSED WIRELESS **TELECOMMUNICATIONS** 

FACILITY

TOWER TYPE:

195' MONOPOLE (199 OVERALL)

SITE ADDRESS:

POYTHRESS ROAD

CHAPEL HILL, NC 27516

(CHATHAM COUNTY)

JURISDICTION:

**CHATHAM COUNTY** 

AREA OF CONSTRUCTION: 12,404 ± SQ. FT.

(LEASE AREA & ACCESS DRIVE)

OCCUPANCY TYPE:

UNDEVELOPED

CURRENT ZONING:

R2

PIN #:

85601


### PROJECT INFORMATION

N 35° 51' 28,053" (NAD '27) LONGITUDE W 79° 07' 22.358" (NAD '27)

N 35° 51' 28.572" (NAD '83) LONGITUDE W 79° 07' 21.404" (NAD '83)


GROUND ELEV. (AMSL) =580.1' (NAVD '88)

### 1-A CERTIFICATION

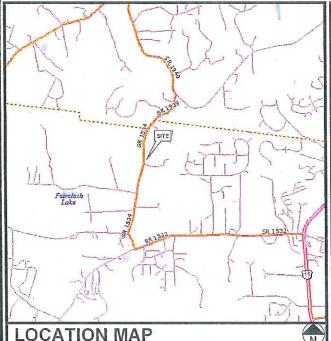

DIRECTIONS BEGINNING FROM BURLINGTON NC: MERGE ONTO 1-40 E/I-85BUS N TOWARD I-85 N/DURHAM/RALEIGH 1.6 MI. MERGE ONTO I-40 E/I-85 N 17.1 MI. TAKE EXIT 147, TOWARD GRAHAM/PITTSBORO, 0.3 MI. TURN RIGHT ONTO NC-87/S MAIN ST. FOLLOW NC-87. 12.6 MI. TURN LEFT ONTO E GREENSBORO CHAPEL HILL RD. 3.0 MI. E GREENSBORO CHAPEL HILL RD BECOMES OLD GREENSBORO RD. 9.2 MI, TURN RIGHT ONTO JONES FERRY RD. 1.8 MI, TURN LEFT ONTO DAMASCUS CHURCH 1.5 MI. TURN RIGHT ONTO MEACHUM RD. MEACHUM RD BECOMES POYTHRESS RD. 0.5 MI. TURN LEFT ONTO CHESTNUT WAY, 189 CHESTNUT WAY IS ON THE LEFT.

### **DRIVING DIRECTIONS**

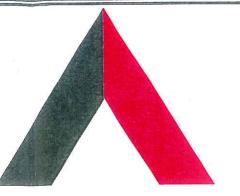

# MERICAN TOWER CORPORATION

SITE PLAN

AT&T SITE #: 368-545

ATC SITE #: 280373

ATC SITE NAME: MEACHAM NC

**POYTHRESS ROAD CHAPEL HILL, NC 27516** 

### SITE PROJECT MANAGER:

NAME: ADDRESS

AMERICAN TOWER COMPANY 400 REGENCY FOREST DRIVE CITY, STATE, ZIP: CARY, NC 27518

JILL HOUSE (919) 466-5163

NAME: AMERICAN TOWER CORPORATION
ADDRESS: 400 REGENCY FOREST DRIVE
CITY, STATE, ZIP: CARY, NC 27518
JILL HOUSE
PHONE:

(919) 466-5163

### SURVEYOR:

NAME. ADDRESS:

TOWER ENGINEERING PROFESSIONALS 3703 JUNCTION BOULEVARD

CITY, STATE, ZIP: RALEIGH, NC 27603 CLIFFORD C. BYRD, P.L.S. (919) 661-6351

### CIVIL ENGINEER:

NAME:

TOWER ENGINEERING PROFESSIONALS ADDRESS: 3703 JUNCTION BOULEVARD CITY, STATE, ZIP: RALEIGH, NC 27603

GRAHAM M. ANDRES, P.E. (919) 661-6351

### **ELECTRICAL ENGINEER:**

NAME. ADDRESS: CONTACT:

TOWER ENGINEERING PROFESSIONALS 3703 JUNCTION BOULEVARD CITY, STATE, ZIP: RALEIGH, NC 27603 CONTACT: FREDERICK T. HERB, P.E. (919) 661-6351

### PROPERTY OWNER:

JAMES & JANE WOMBLE ADDRESS: 189 CHESTNUT WAY CITY, STATE, ZIP: CHAPEL HILL, NC 27516 JAMES & JANE WOMBLE 919-933-1374

### UTILITIES:

POWER COMPANY: CONTACT: METER # NEAR SITE:

TELEPHONE COMPANY: CONTACT:

SOUTHERN BELL CUSTOMER SERVICE PHONE # NEAR SITE: PEDESTAL # NEAR SITE: 919-933-1347

### CONTACT INFORMATION

ALL WORK AND MATERIALS SHALL BE PERFORMED AND INSTALLED IN ACCORDANCE WITH THE CURRENT EDITIONS OF THE FOLLOWING CODES
AS ADOPTED BY THE LOCAL GOVERNING AUTHORITIES, NOTHING IN THESE
PLANS IS TO BE CONSTRUED TO PERMIT WORK NOT CONFORMING TO THE LATEST EDITIONS OF THE FOLLOWING:

1 NORTH CAROLINA BUILDING CODE 4, 2012 NOEC (2012 EDITION)

2. NORTH CAROLINA CODE COUNCIL

3. ANSI/TIA-222-G-2-2009

4. 2012 NOCEC
(NEC 2011 + ADDENDA)
5. LOCAL BUILDING CODE
6. CITY/COUNTY ORDINANCES

PROGRESS ENERGY

CUSTOMER SERVICE

800-452-2777

### CODE COMPLIANCE

N1	GENERAL NOTES	1 1
C1	SITE PLAN	1
C2	COMPOUND DETAIL	1
C3	TOWER ELEVATION	1
C4	SHELTER ELEVATIONS	1
C5	SHELTER FOUNDATION DETAILS	1
C6	GENERATOR & FUEL TANK ELEVATIONS	1
C7	GENERATOR FOUNDATION DETAILS	1
C8	ICE BRIDGE DETAILS I	1
C9	ICE BRIDGE DETAILS II	1
C10	FENCE DETAILS	1
C11	SIGNAGE DETAILS	1
C12	CULVERT & DRIVEWAY DETAILS	1
C13	SOIL & EROSION CONTROL PLAN	1
C14	PIPE OUTLET PROTECTION DETAILS	1
E1	ELECTRICAL NOTES	1
E2	SERVICE ROUTING PLAN & ONE LINE DIAGRAM	1
E3	TOWER & SHELTER GROUNDING PLAN	1
E4	PANELBOARD SCHEDULE	1
E5	SERVICE RACK DETAILS I	1
E5A	SERVICE RACK DETAILS II	1
E6	GROUNDING DETAILS I	1
E7	GROUNDING DETAILS II	1
		1
		-

INDEX OF SHEETS

SHEET DESCRIPTION

T1 TITLE SHEET

# TOWER ENGINEERING PROFESSIONALS 3703 JUNCTION BOULEVARD RALEIGH, NC 27603-5263 OFFICE: (919) 661-6351 www.tepgroup.net N.C. LICENSE # C-1794 07-19-13 CONSTRUCTION 05-22-13 PRELIMINARY DATE REV ISSUED FOR: DRAWN BY: CHECKED BY: KW.I

REV

PLANS PREPARED BY:



Second M. Pine

REVISION:

TEP #: 13150

- ALL REFERENCES MADE TO OWNER IN THESE DOCUMENTS SHALL BE CONSIDERED ATC OR IT'S DESIGNATED REPRESENTATIVE.
- 2. ALL WORK PRESENTED ON THESE DRAWINGS MUST BE COMPLETED BY THE CONTRACTOR UNLESS NOTED OTHERWISE. THE CONTRACTOR MUST HAVE CONSIDERABLE EXPERIENCE IN PERFORMANCE OF WORK SIMILAR TO THAT DESCRIBED HEREIN. BY ACCEPTANCE OF THIS ASSIGNMENT, THE CONTRACTOR IS ATTESTING THAT HE DOES HAVE SUFFICIENT EXPERIENCE AND ABILITY, THAT HE IS KNOWLEDGEABLE OF THE WORK TO BE PERFORMED AND THAT HE IS PROPERLY LICENSED AND PROPERLY REGISTERED TO DO THIS WORK IN THE STATE OF NORTH CAROLINA.
- 3. THE STRUCTURE SHALL BE DESIGNED IN ACCORDANCE WITH ANSI/TIA-222-G-2-2009. THIS CONFORMS TO THE REQUIREMENTS OF THE NORTH CAROLINA BUILDING CODE, 2012 EDITION.
- 4. WORK SHALL BE COMPLETED IN ACCORDANCE WITH THE NORTH CAROLINA BUILDING CODE, 2012 EDITION.
- 5. UNLESS SHOWN OR NOTED OTHERWISE ON THE CONTRACT DRAWINGS, OR IN THE SPECIFICATIONS, THE FOLLOWING NOTES SHALL APPLY TO THE MATERIALS LISTED HEREIN, AND TO THE PROCEDURES TO BE USED ON THIS PROJECT.
- 6. ALL HARDWARE ASSEMBLY MANUFACTURER'S INSTRUCTIONS SHALL BE FOLLOWED EXACTLY AND SHALL SUPERSEDE ANY CONFLICTING NOTES ENCLOSED HEREIN.
- 7. IT IS THE CONTRACTOR'S SOLE RESPONSIBILITY TO DETERMINE ERECTION PROCEDURE AND SEQUENCE TO INSURE THE SAFETY OF THE STRUCTURE AND IT'S COMPONENT PARTS DURING ERECTION AND/OR FIELD MODIFICATIONS. THIS INCLUDES, BUT IS NOT LIMITED TO, THE ADDITION OF TEMPORARY BRACING, GUYS OR TIE DOWNS THAT MAY BE NECESSARY. SUCH MATERIAL SHALL BE REMOVED AND SHALL REMAIN THE PROPERTY OF THE CONTRACTOR AFTER THE COMPLETION OF THE PROJECT.
- 8. ALL DIMENSIONS, ELEVATIONS, AND EXISTING CONDITIONS SHOWN ON THE DRAWINGS SHALL BE FIELD VERIFIED BY THE CONTRACTOR PRIOR TO BEGINNING ANY MATERIALS ORDERING, FABRICATION OR CONSTRUCTION WORK ON THIS PROJECT. CONTRACTOR SHALL NOT SCALE CONTRACT DRAWINGS IN LIEU OF FIELD VERIFICATION. ANY DISCREPANCIES SHALL BE IMMEDIATELY BROUGHT TO THE ATTENTION OF THE OWNER AND THE OWNER'S ENGINEER. THE DISCREPANCIES MUST BE RESOLVED BEFORE THE CONTRACTOR IS TO PROCEED WITH THE WORK. THE CONTRACT DOCUMENTS DO NOT INDICATE THE METHOD OF CONSTRUCTION. THE CONTRACTOR SHALL SUPERVISE AND DIRECT THE WORK AND SHALL BE SOLELY RESPONSIBLE FOR ALL CONSTRUCTION MEANS, METHODS, TECHNIQUES, SEQUENCES, AND PROCEDURES. OBSERVATION VISITS TO THE SITE BY THE OWNER AND/OR THE ENGINEER SHALL NOT INCLUDE INSPECTION OF THE PROTECTIVE MEASURES OR THE PROCEDURES.
- 9. ALL MATERIALS AND EQUIPMENT FURNISHED SHALL BE NEW AND OF GOOD QUALITY, FREE FROM FAULTS AND DEFECTS AND IN CONFORMANCE WITH THE CONTRACT DOCUMENTS. ANY AND ALL SUBSTITUTIONS MUST BE PROPERLY APPROVED AND AUTHORIZED IN WRITING BY THE OWNER AND ENGINEER PRIOR TO INSTALLATION. THE CONTRACTOR SHALL FURNISH SATISFACTORY EVIDENCE AS TO THE KIND AND QUALITY OF THE MATERIALS AND EQUIPMENT BEING SUBSTITUTED.
- 10. THE CONTRACTOR SHALL BE RESPONSIBLE FOR INITIATING, MAINTAINING, AND SUPERVISING ALL SAFETY PRECAUTIONS AND PROGRAMS IN CONNECTION WITH THE WORK. THE CONTRACTOR IS RESPONSIBLE FOR INSURING THAT THIS PROJECT AND RELATED WORK COMPLIES WITH ALL APPLICABLE LOCAL, STATE, AND FEDERAL SAFETY CODES AND REGULATIONS GOVERNING THIS WORK.
- 11. ACCESS TO THE PROPOSED WORK SITE MAY BE RESTRICTED. THE CONTRACTOR SHALL COORDINATE INTENDED CONSTRUCTION ACTIVITY, INCLUDING WORK SCHEDULE AND MATERIALS ACCESS, WITH THE AT&T PROJECT MANAGER.
- 12. BILL OF MATERIALS AND PART NUMBERS LISTED ON CONSTRUCTION DRAWINGS ARE INTENDED TO AID CONTRACTOR/OWNER. CONTRACTOR/OWNER SHALL VERIFY PARTS AND QUANTITIES WITH MANUFACTURER PRIOR TO BIDDING AND/OR ORDERING MATERIALS.
- 13. ALL PERMITS THAT MUST BE OBTAINED ARE THE RESPONSIBILITY OF THE CONTRACTOR. THE CONTRACTOR WILL BE RESPONSIBLE FOR ABIDING BY ALL CONDITIONS AND REQUIREMENTS OF THE PERMITS.
- 14. 24 HOURS PRIOR TO THE BEGINNING OF ANY CONSTRUCTION, THE CONTRACTOR MUST NOTIFY THE APPLICABLE JURISDICTIONAL (STATE, COUNTY OR CITY) ENGINEER.
- 15. THE CONTRACTOR SHALL REWORK (DRY, SCARIFY, ETC.) ALL MATERIAL NOT SUITABLE FOR SUBGRADE IN ITS PRESENT STATE. AFTER REWORKING, IF THE MATERIAL REMAINS UNSUITABLE, THE CONTRACTOR SHALL UNDERCUT THIS MATERIAL AND REPLACE WITH APPROVED MATERIAL. ALL SUBGRADES SHALL BE PROOFFICILED WITH A FULLY LOADED TANDEM AXLE DUMP TRUCK PRIOR TO PAVING. ANY SOFT MATERIAL SHALL BE REWORKED OR REPLACED.
- 16. THE CONTRACTOR IS REQUIRED TO MAINTAIN ALL PIPES, DITCHES, AND OTHER DRAINAGE STRUCTURES FREE FROM OBSTRUCTION UNTIL WORK IS ACCEPTED BY THE OWNER. THE CONTRACTOR IS RESPONSIBLE FOR ANY DAMAGES CAUSED BY FAILURE TO MAINTAIN DRAINAGE STRUCTURE IN OPERABLE CONDITION.
- 17. ALL MATERIALS AND WORKMANSHIP SHALL BE WARRANTED FOR ONE YEAR FROM ACCEPTANCE DATE.
- 18. ALL BUILDING DIMENSIONS SHALL BE VERIFIED WITH THE PLANS (LATEST REVISION) PRIOR TO COMMENCING CONSTRUCTION. NOTIFY THE ENGINEER IMMEDIATELY IF ANY DISCREPANCIES ARE DISCOVERED. THE OWNER SHALL HAVE A SET OF APPROVED PLANS AVAILABLE AT THE SITE AT ALL TIMES WHILE WORK IS BEING PERFORMED. A DESIGNATED RESPONSIBLE EMPLOYEE SHALL BE AVAILABLE FOR CONTACT BY GOVERNING AGENCY INSPECTORS.

- ANY BUILDINGS ON THIS SITE ARE INTENDED TO SHELTER EQUIPMENT WHICH WILL ONLY BE PERIODICALLY MAINTAINED AND ARE NOT INTENDED FOR HUMAN OCCUPANCY.
- 20. TEMPORARY FACILITIES FOR PROTECTION OF TOOLS AND EQUIPMENT SHALL CONFORM TO LOCAL REGULATIONS AND SHALL BE THE CONTRACTOR'S RESPONSIBILITY.
- 1. RENTAL CHARGES, SAFETY, PROTECTION AND MAINTENANCE OF RENTED EQUIPMENT SHALL BE THE CONTRACTOR'S RESPONSIBILITY.
- 22. THE CONTRACTOR AND ITS SUBCONTRACTORS SHALL CARRY LIABILITY INSURANCE IN THE AMOUNTS AND FORM IN ACCORDANCE WITH AT&T SPECIFICATIONS. CERTIFICATES DEMONSTRATING PROOF OF COVERAGE SHALL BE PROVIDED TO AT&T PRIOR TO THE START OF THE WORK ON THE PROJECT.
- 23. THESE DOCUMENTS DO NOT INCLUDE THE NECESSARY COMPONENTS FOR CONSTRUCTION SAFETY, SAFETY, CARE OF ADJACENT PROPERTIES, AND COMPLIANCE WITH STATE AND FEDERAL REGULATIONS REGARDING SAFETY, SHALL BE THE CONTRACTOR'S RESPONSIBILITY.
- 24. THE CONTRACTOR SHALL CONTACT ALL APPLICABLE UTILITY SERVICES TO VERIFY LOCATIONS OF EXISTING UTILITIES AND REQUIREMENTS FOR NEW UTILITY CONNECTIONS PRIOR TO EXCAVATING.
- 25. THE CONTRACTOR SHALL MAINTAIN THE JOB CLEAR OF TRASH AND DEBRIS. ALL WASTE MATERIALS SHALL BE REMOVED FROM THE SITE PRIOR TO SUBSTANTIAL COMPLETION AND PRIOR TO FINAL ACCEPTANCE. THE CONTRACTOR SHALL FURNISH ONE 55 GALLON BARREL, AND TRASH BAGS, AND SHALL REMOVE TRASH, DEBRIS, ETC., ON A DAILY BASIS.
- 26. COSTS FOR BUILDING PERMITS, LANDFILL TAXES, USE TAXES, SALES TAXES AND OTHER CHARGES RELATIVE TO CONSTRUCTION OF THIS PROJECT SHALL BE INCLUDED IN THE CONTRACT PRICE.
- 27. THE CONTRACTOR SHALL VISIT THE SITE AND BECOME FAMILIAR WITH ALL CONDITIONS PRIOR TO SUBMITTING HIS PROPOSAL. CONTRACTOR SHALL VERIFY ALL DIMENSIONS AND CONDITIONS SHOWN ON THESE DRAWINGS WITH THOSE AT THE SITE, ANY VARIATION WHICH REQUIRES PHYSICAL CHANGE SHALL BE BROUGHT TO THE ATTENTION OF THE ATC PROJECT ENGINEER FOR FACILITIES/CONSTRUCTION.
- 28. THE CONTRACTOR SHALL GUARANTEE THE WORK PERFORMED ON THE PROJECT BY THE CONTRACTOR AND ANY OR ALL OF THE SUBCONTRACTORS WHO PERFORMED WORK FOR THE CONTRACTOR ON THIS PROJECT. THE GUARANTEE SHALL BE FOR A FULL YEAR FOLLOWING ISSUANCE OF THE FINAL PAYMENT OF RETAINAGE.



PROJECT INFORMATION:

### AT&T SITE #: 368-545 ATC#: 280373 MEACHAM NC


CARY, NC 27511

POYTHRESS ROAD CHAPEL HILL, NC 27516 (CHATHAM COUNTY)



TOWER ENGINEERING PROFESSIONALS
3703 JUNCTION BOULEVARD
RALEIGH, NC 27603-5263
OFFICE: (919) 661-6351
www.tepgroup.net

N.C. LICENSE #C-1794

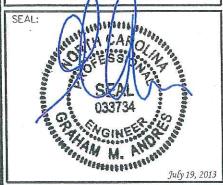

| 1 07-19-13 | CONSTRUCTION | 0 05-22-13 | PRELIMINARY | REV | DATE | ISSUED FOR:

DRAWN BY: SCB CHECKED BY: GMA

SHEET TITLE:

GENERAL NOTES


SHEET NUMBER:


: REVISION:


TEP #: 13150


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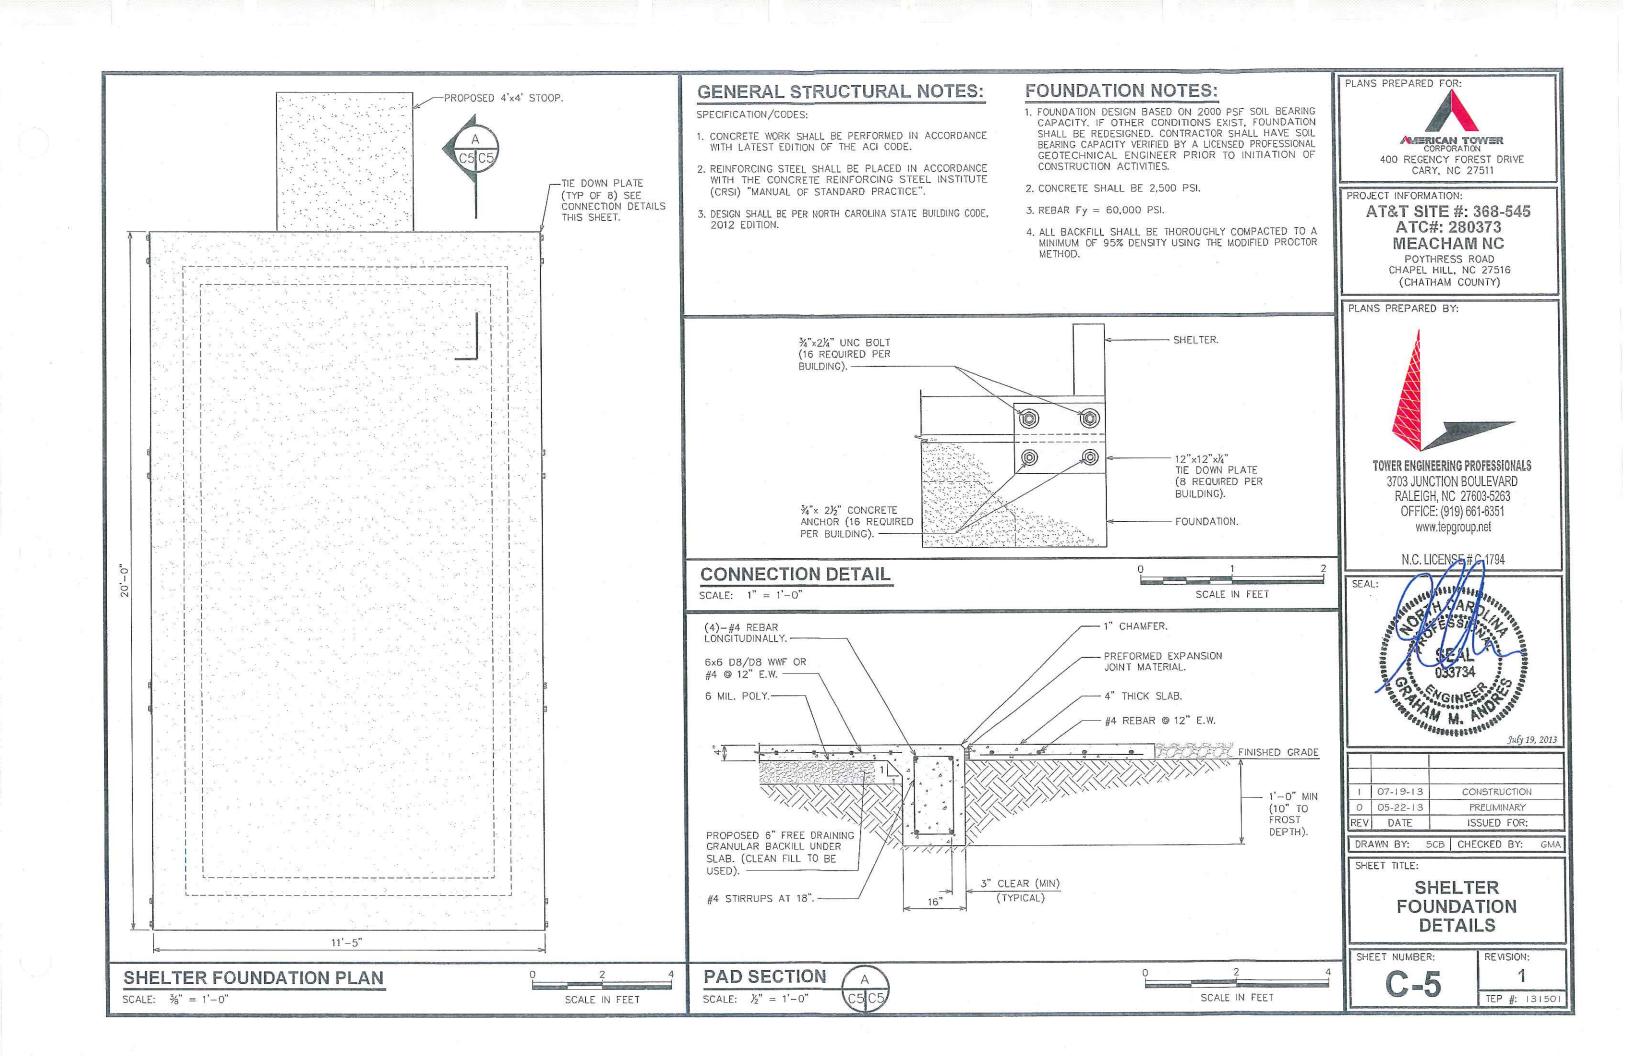
**GENERAL NOTES** 




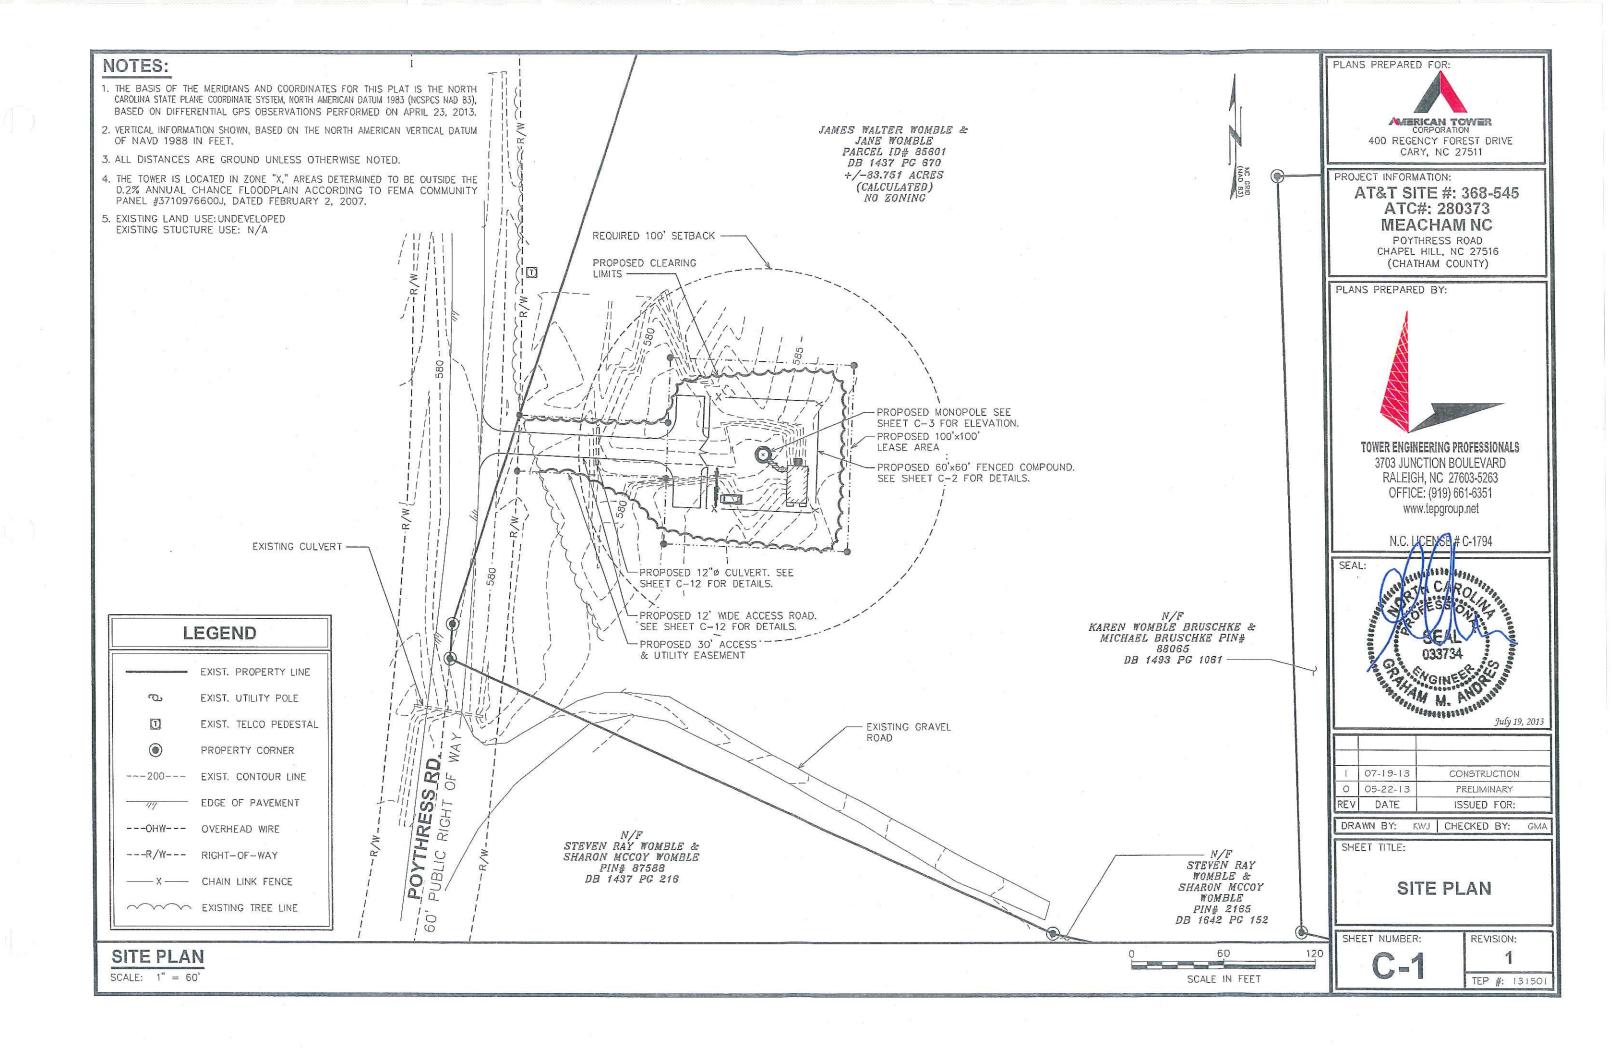


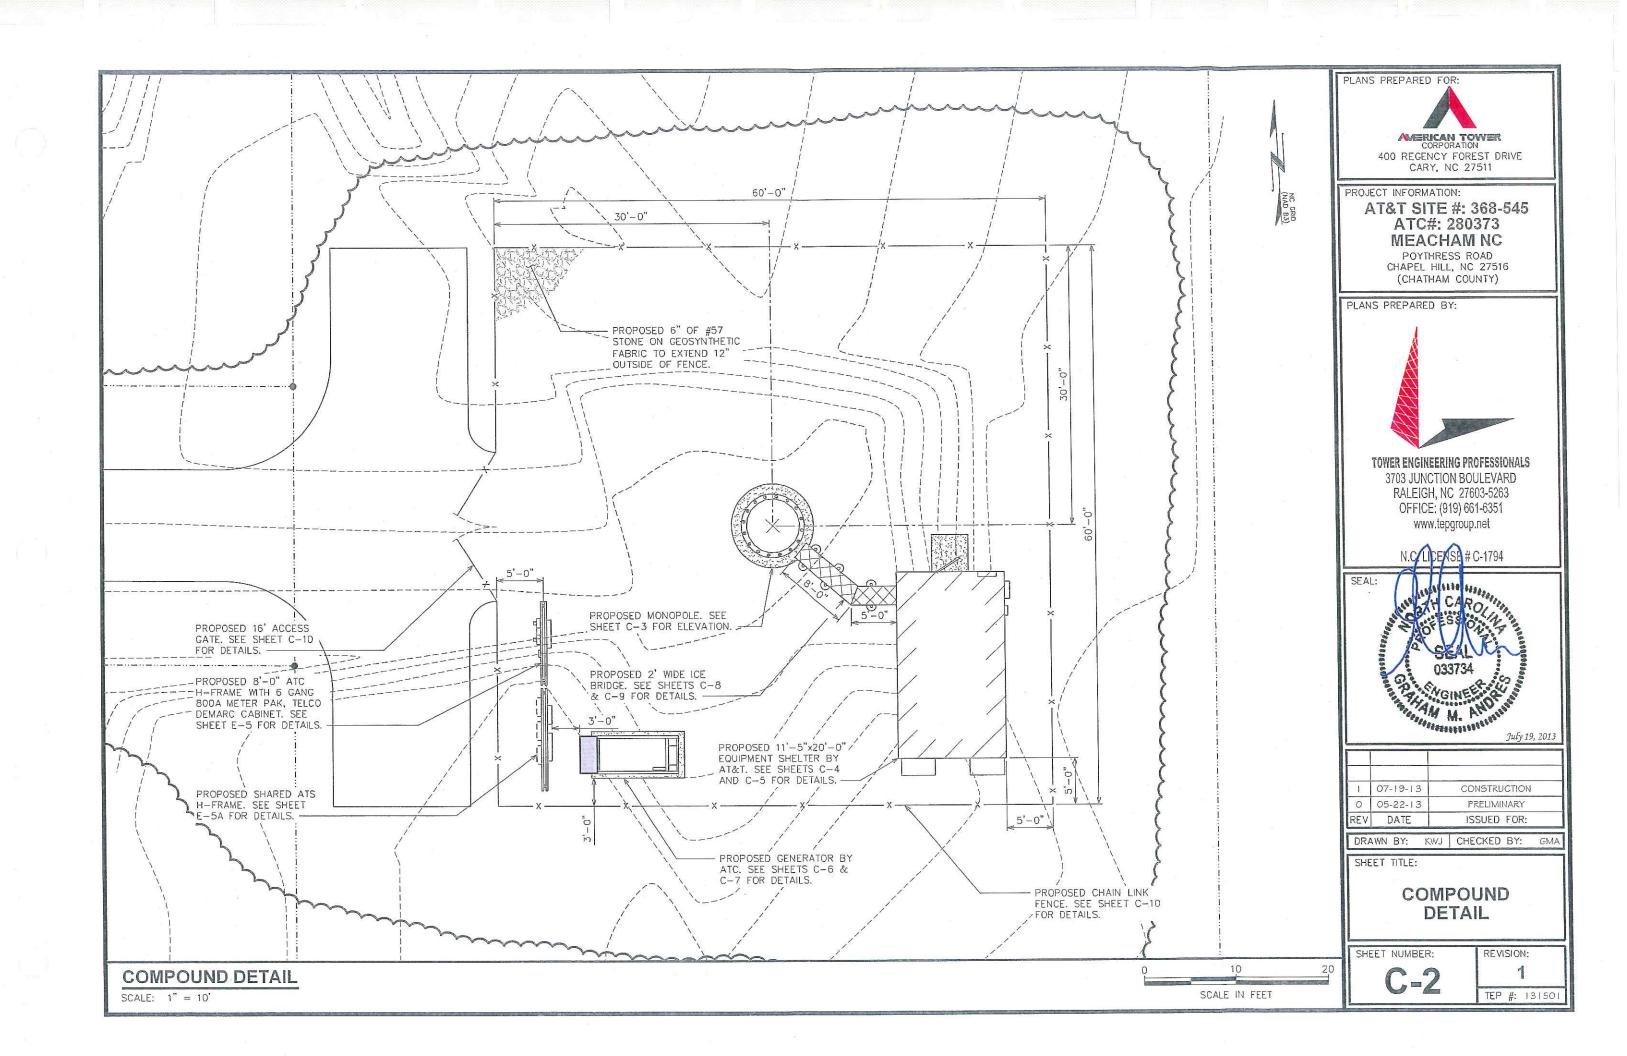


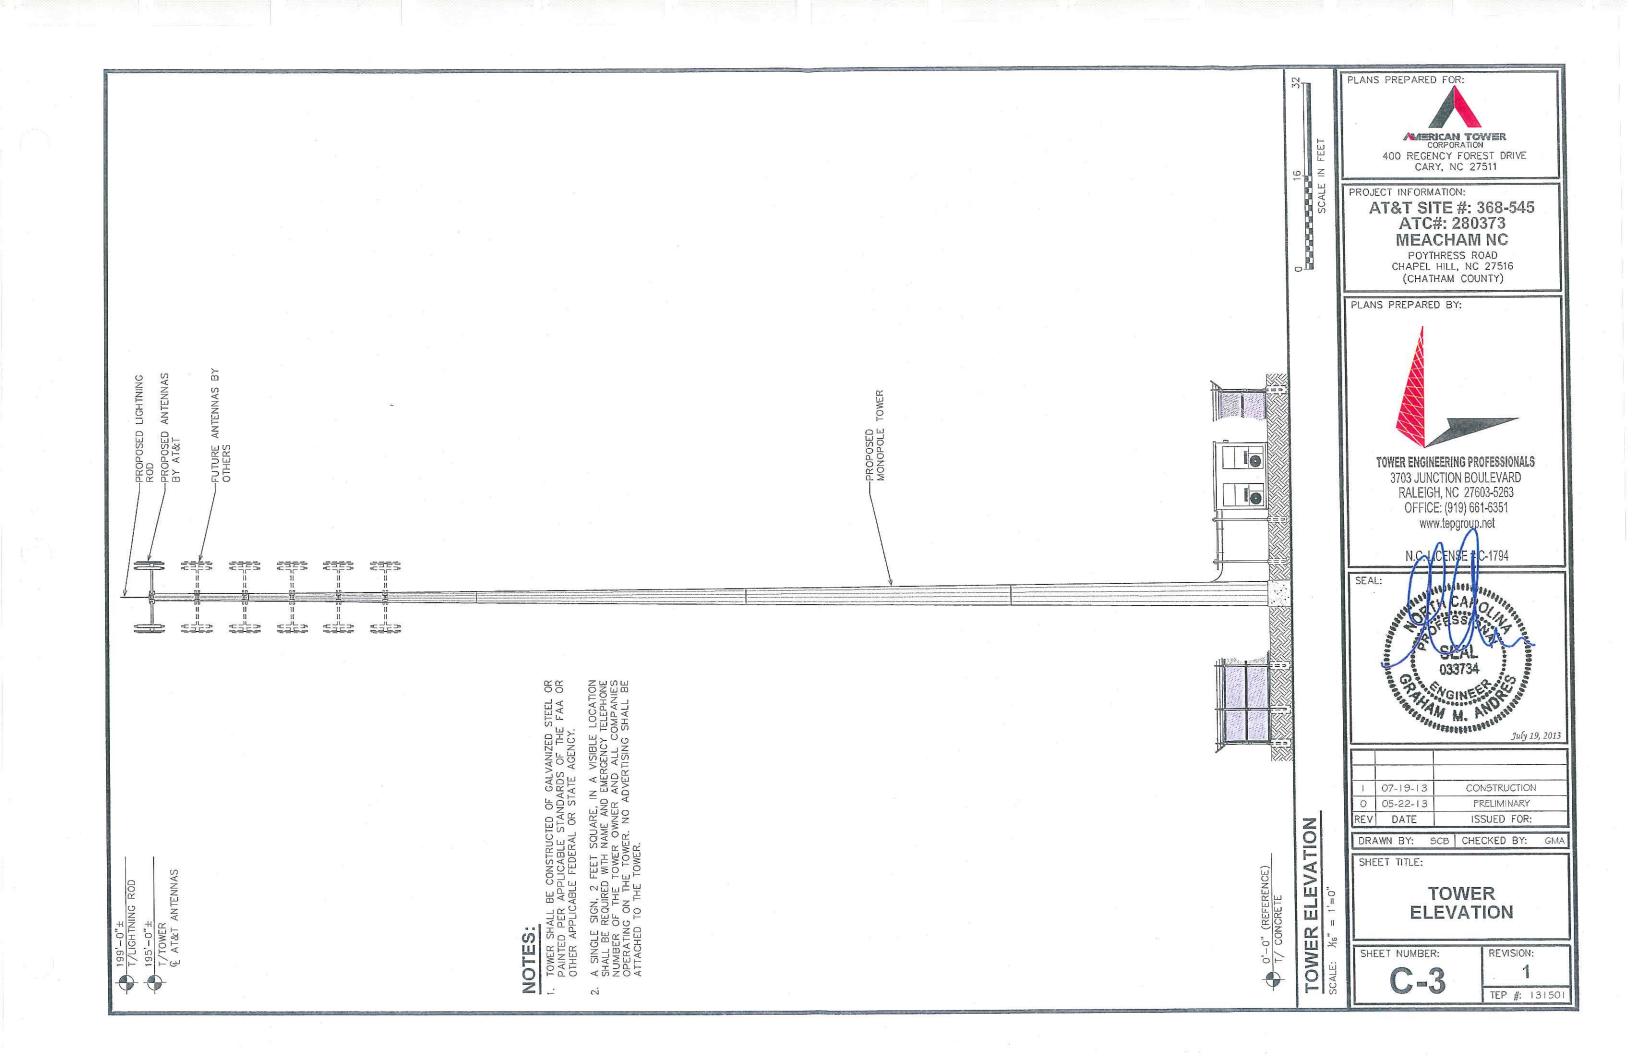


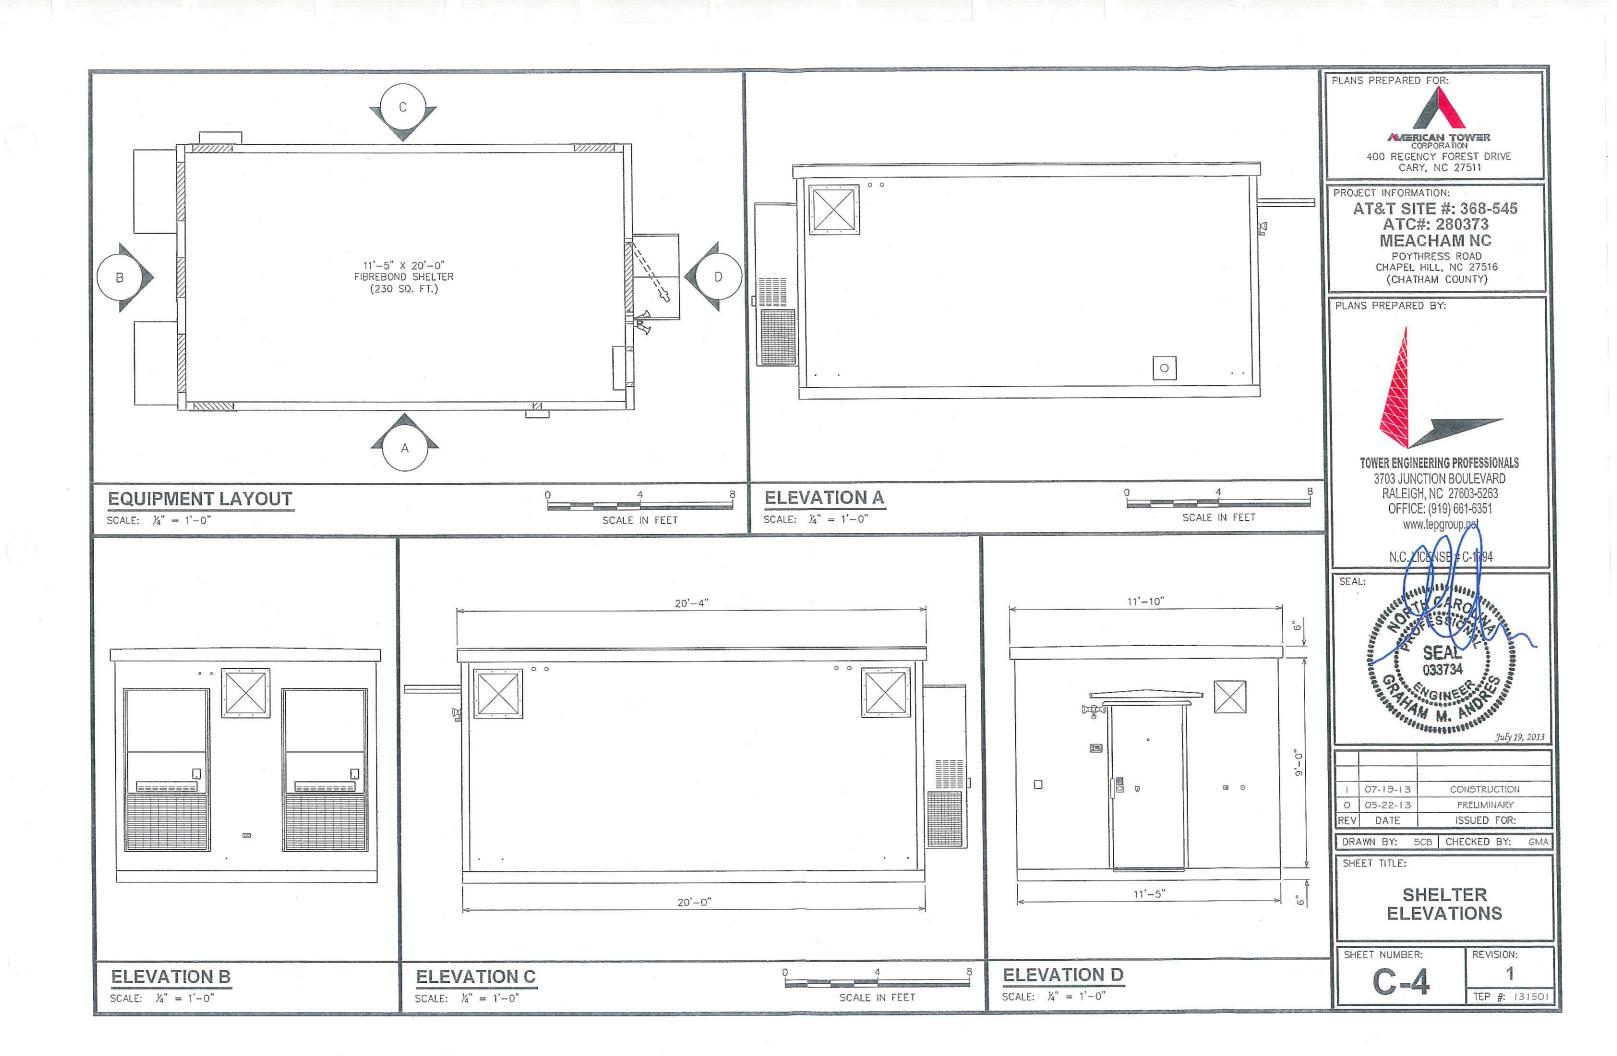

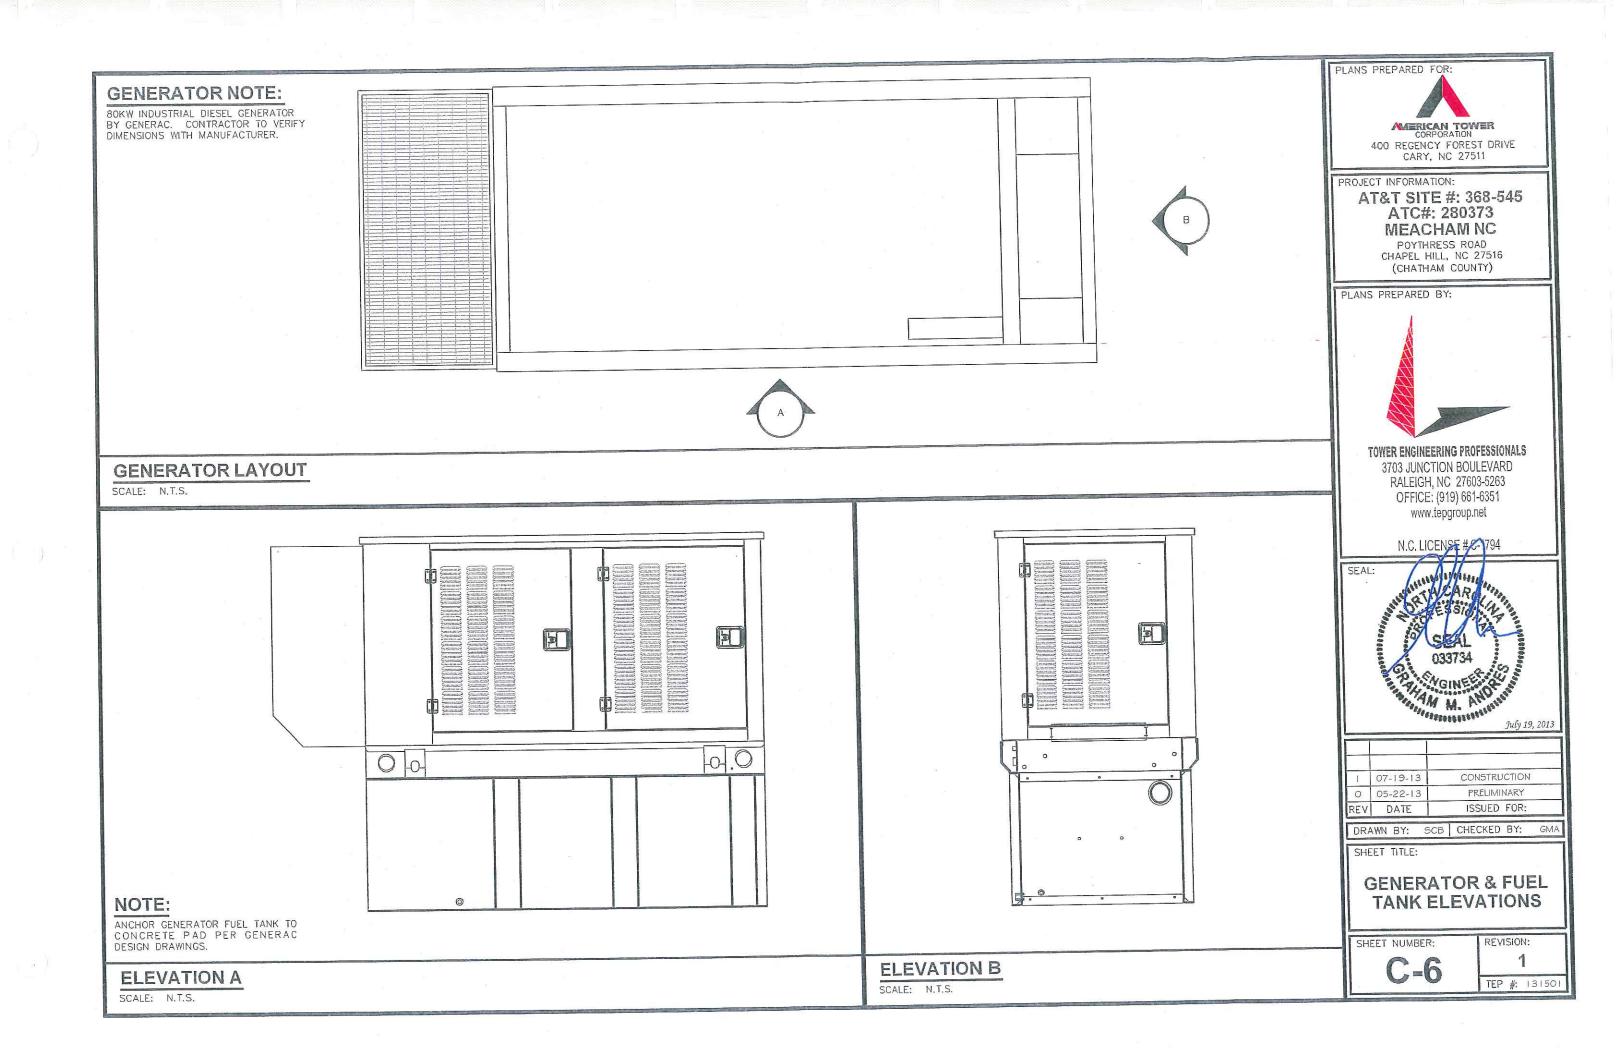

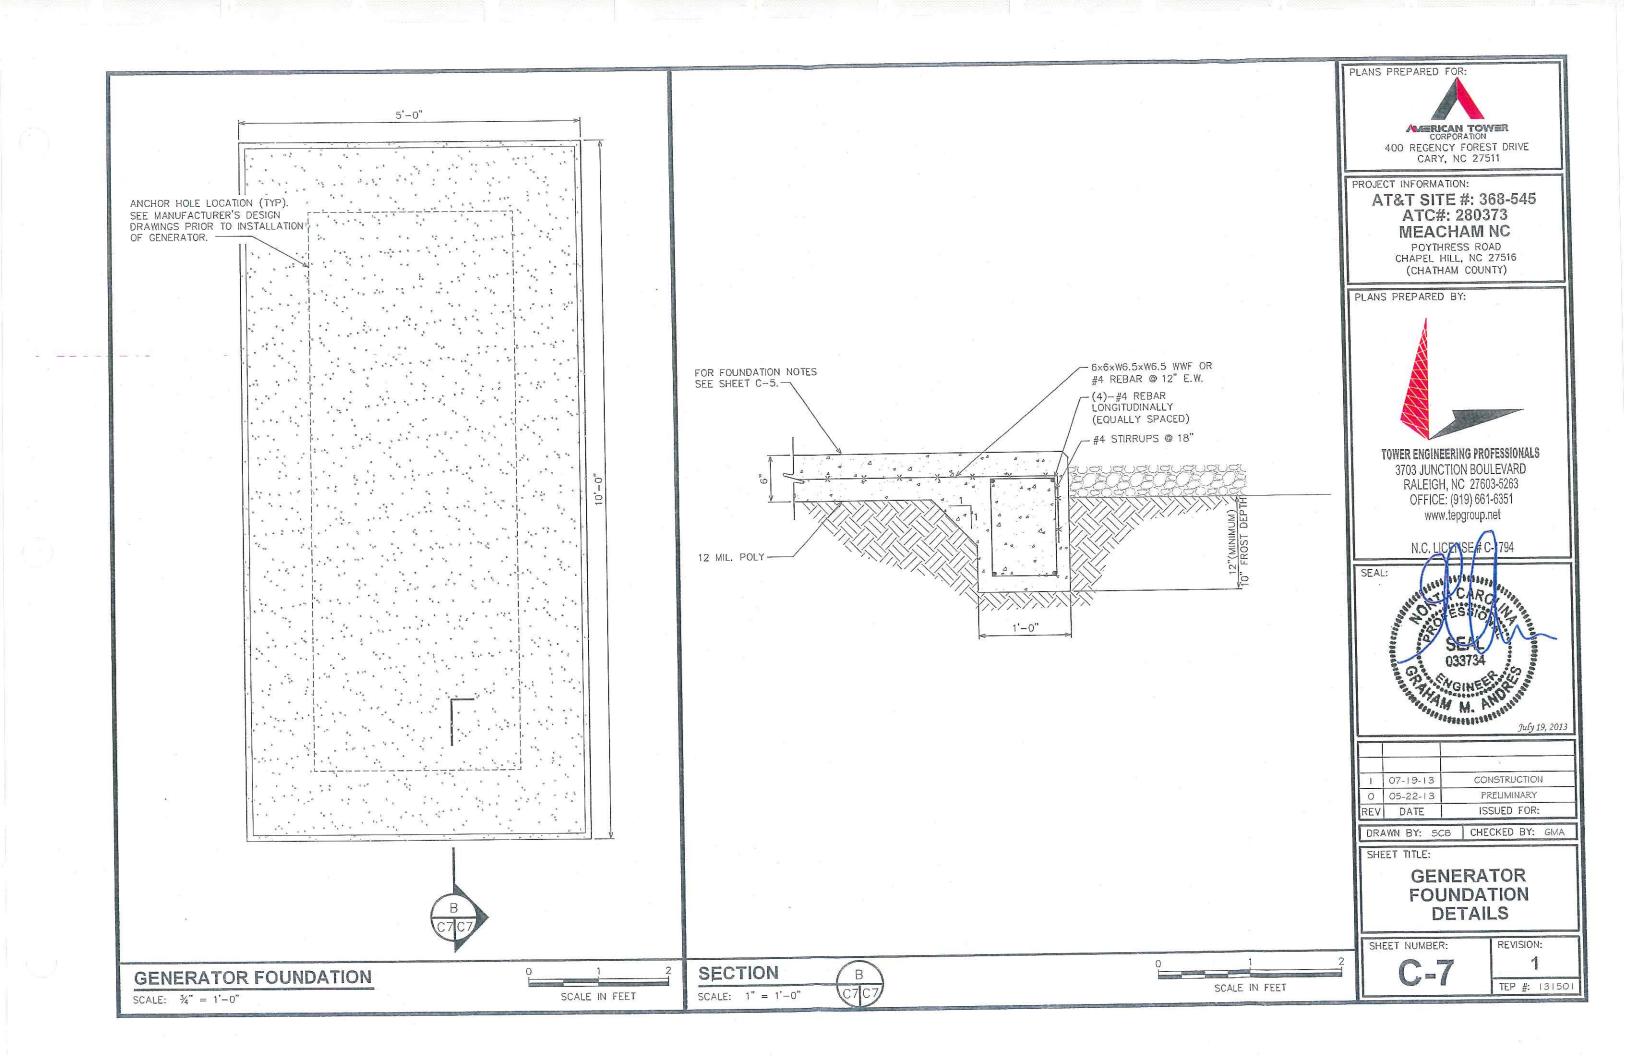

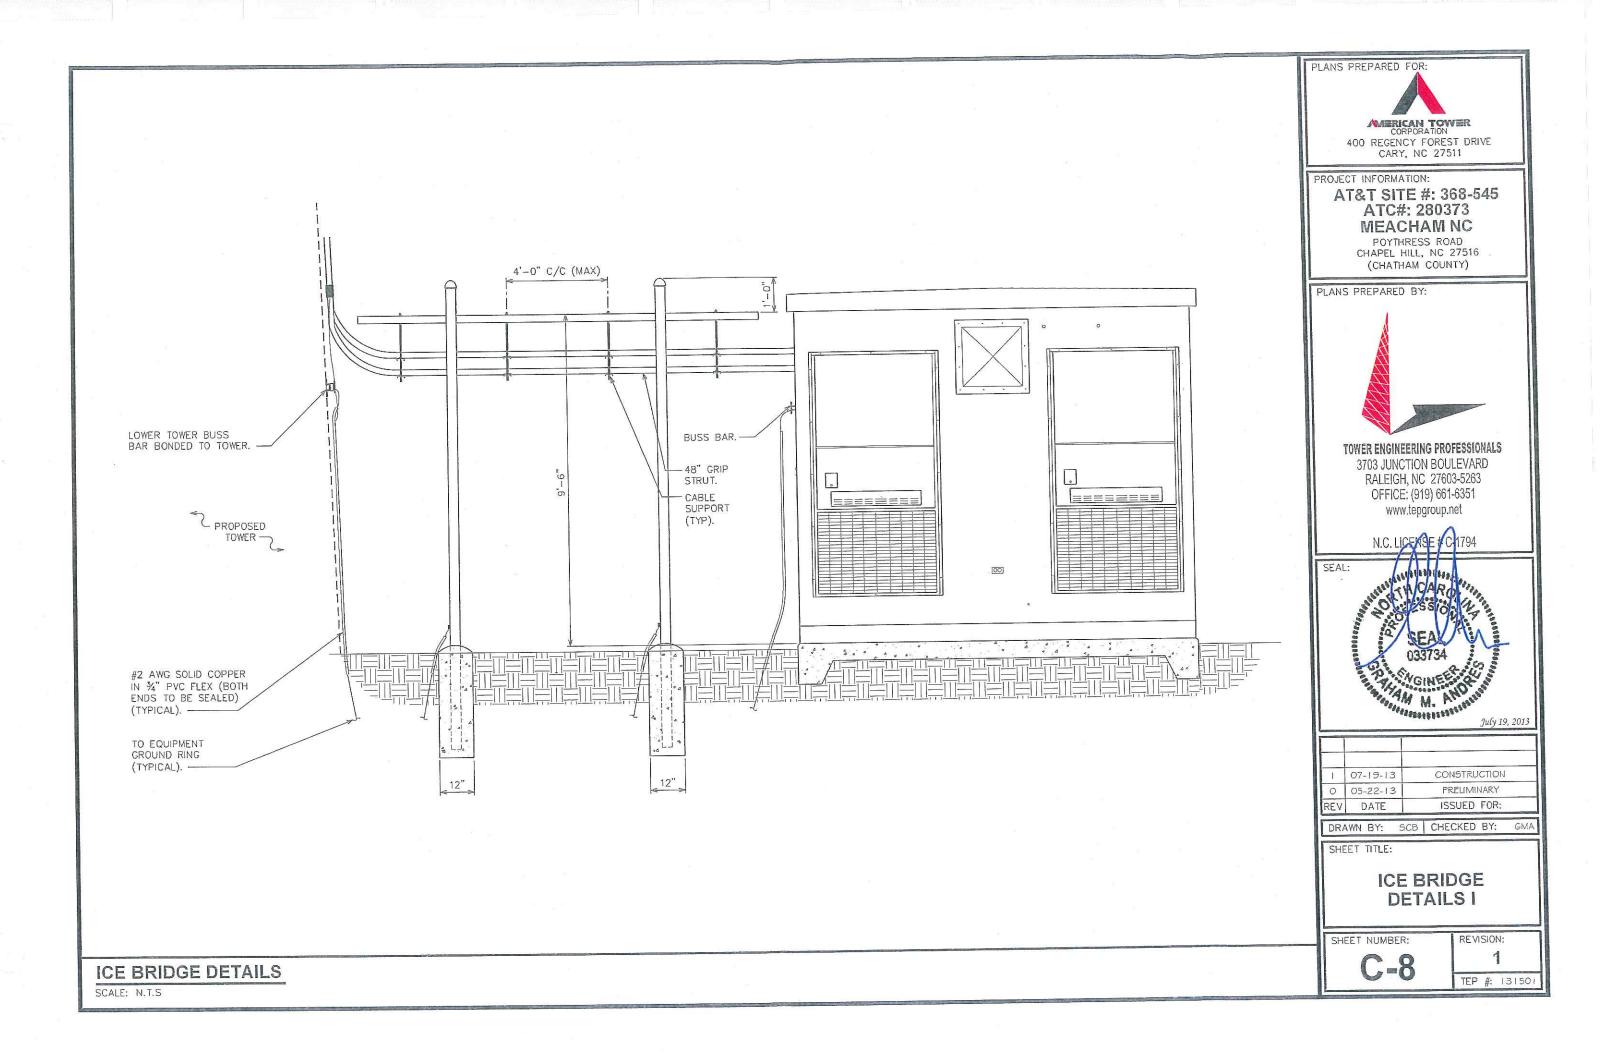

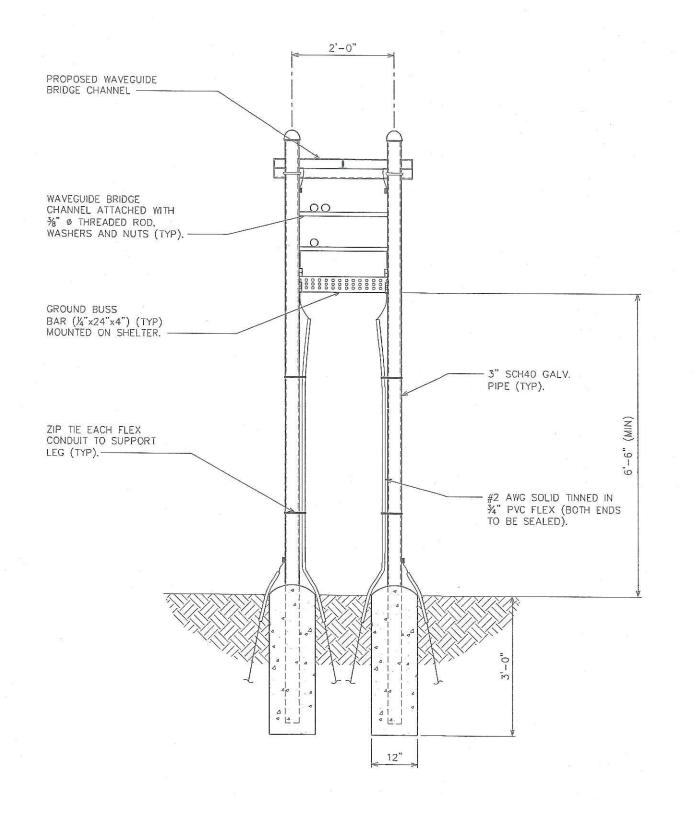

PLANS PREPARED FOR:



CORPORATION

400 REGENCY FOREST DRIVE
CARY, NC 27511

PROJECT INFORMATION:

### AT&T SITE #: 368-545 ATC#: 280373 MEACHAM NC

POYTHRESS ROAD CHAPEL HILL, NC 27516 (CHATHAM COUNTY)

PLANS PREPARED BY:



### TOWER ENGINEERING PROFESSIONALS

3703 JUNCTION BOULEVARD RALEIGH, NC 27603-5263 OFFICE: (919) 661-6351 www.tepgroup.net

N.C. LICENSE # C-1794



1	07-19-13	CONSTRUCTION
0	05-22-13	PRELIMINARY
REV	DATE	ISSUED FOR:

DRAWN BY: JJM CHECKED BY: JAS

SHEET TITLE:

ICE BRIDGE DETAILS II

SHEET NUMBER:


C=9

REVISION: 1 TEP #: 13150

ICE BRIDGE DETAILS

SCALE:  $\frac{1}{2}$ " = 1'-0"

SCALE IN FEET

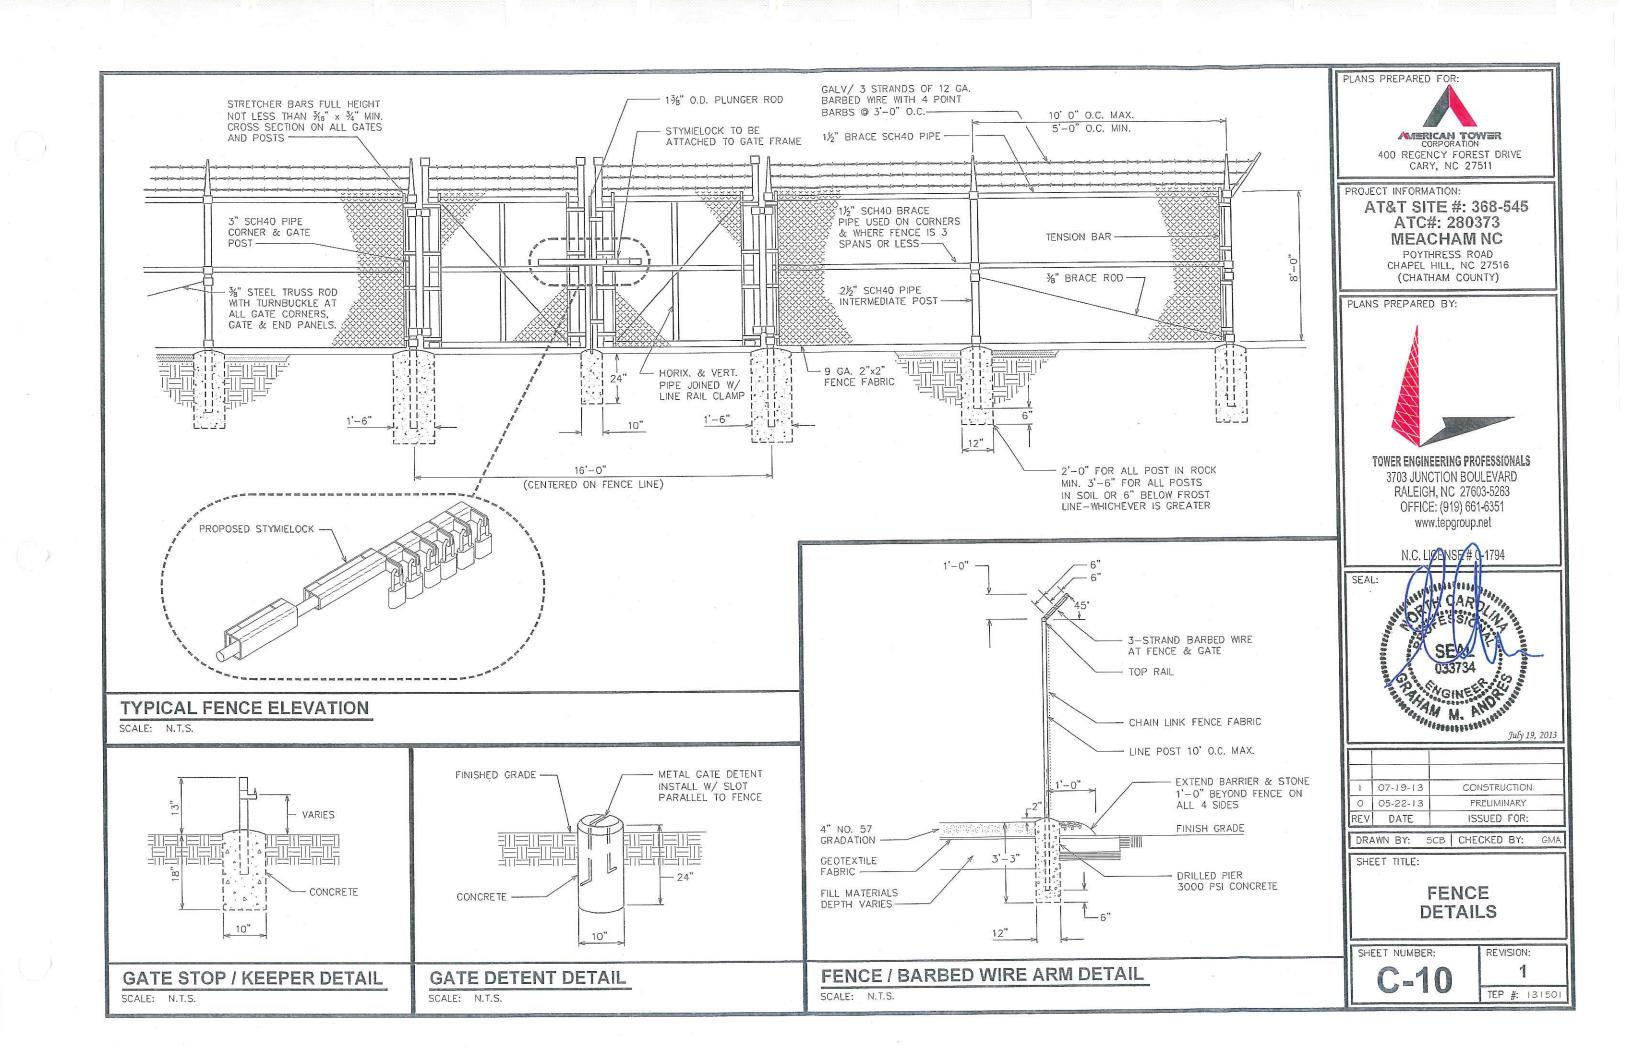

property of



### AUTHORIZED PERSONNEL ONLY!

In case of emergency or prior to performing maintenance on this site, call 1-800-638-2822 and reference cell site number:

1) WHITE/BLUE BACKGROUND W/ BLACK LETTERING QUANTITY: (1)

SIZE: 9"X12"

(TO BE MOUNTED ON UNIVERSAL POWER CABINET DOOR ADJACENT TO COMPOUND ENTRY - SEE NOTE 3)

## NO TRESSPASSING

**VIOLATORS WILL BE PROSECUTED** 

property of



CORPORATION

400 RESERVEY FOREST DR.
CARY NO FEETING.

In case of emergency or prior to performing maintenance on this site, call 1-800-830-3365 and reference cell site number:

3 WHITE/RED BACKGROUND W/ BLACK LETTERING QUANTITY: (4)
SIZE: 12"X12"

(ONE TO BE MOUNTED ON EACH SIDE OF COMPOUND FENCE)

### DO NOT CLIMB TOWER WITHOUT OWNER'S WRITTEN PERMISSION

(4) WHITE BACKGROUND W/ RED LETTERING
QUANTITY: (1)
(TO BE MOUNTED AT EYE LEVEL ON TOWER

NEAR SAFETY CLIMB)

NOTICE



Radio Frequency fields beyond this point may exceed the FCC general public exposure limit.

OBEY ALL POSTED SIGNS AND SITE GUIDELINES FOR WORKING IN RADIO FREQUENCY ENVIRONMENTS.

in occordance with Federal Communications Commission rule on realin incommer expenses 47 CFR 1,1307(b)

(2) WHITE/BLUE BACKGROUND
W/ BLACK LETTERING
QUANTITY: (1)
(TO BE MOUNTED AT EYE
LEVEL ON TOWER NEAR
SAFETY CLIMB)

000

- 5 WHITE BACKGROUND W/ BLACK LETTERING
  E911 STREET #
  QUANTITY: (1 TYP)
  LETTERS MUST BE A MINIMUM 6" TALL
  (TO BE MOUNTED ON THE GATE OF COMPOUND)
- 1) SITE IDENTIFICATION SIGN
- 2) FCC/RF EXPOSURE SIGN
- (3) AUTHORIZED ENTRY SIGN
- 4) TOWER CLIMBING SIGN
- (5) STREET ADDRESS SIGN
- 6 INFORMATION RF EXPOSURE SIGN
- 7 TOWER REGISTRATION SIGN

# INFORMATION

AMERICAN TOWER operates telecommunications equipment at this location.

Stay back a minimum of 3 feet from any antenna.

Obey all posted signs and guidelines.

Do not cross into areas restricted by striping and/or barriers.

Contact the owner(s) of the antenna(s) and follow their instructions prior to performing any repairs or maintenance within a restricted area of closer than 3 feet from the antenna.

Contact AMERICAN TOWER at 1-800-830-3365 prior to doing any work near AMERICAN TOWER structures. This is site #-----

Contact the management office if this door/hatch/gate is found unlocked.

(TO BE MOUNTED ON COMPOUND ACCESS GATE)

# FCC TOWER REGISTRATION NO.: 0123456789

(7) WHITE BACKGROUND W/ BLACK LETTERING
QUANTITY: (1)
(TO BE MOUNTED ON COMPOUND ACCESS GATE — SEE NOTE 5)
NOTE: NUMBER SHOWN IS GENERIC, CONTACT CONSTRUCTION MANAGER
FOR ACTUAL FCC TOWER REG. #.

### NOTES:

- SIGNS SHALL MEASURE 8"x12", BE FABRICATED FROM CORROSION RESISTANT PRESSED METAL, AND PAINTED WITH LONG LASTING UV RESISTANT COATINGS.
- SIGNS (EXCEPT WHERE NOTED OTHERWISE) SHALL BE MOUNTED TO THE TOWER, GATE AND FENCE USING A MINIMUM OF 9 GAUGE ALUMINUM WIRE, HOG RINGS (AS UTILIZED IN FENCE INSTALLATIONS) OR BRACKETS WHERE NECESSARY. BRACKETS SHALL BE OF SIMILAR METAL AS THE STRUCTURE TO AVOID GALVANIC CORROSION.
- AMERICAN TOWER SITE # AND EMERGENCY CONTACT # SHALL BE MOUNTED ON THE UNIVERSAL POWER CABINET DOOR ADJACENT TO THE COMPOUND ENTRY WITH PERMANENT SET ADHESIVE. TWO—SIDED TAPE SHALL BE UTILIZED AT EACH CORNER ON THE BACKSIDE TO AID PLACEMENT UNTIL ADHESIVE SETS.
- 4. ADDITIONAL E911 ADDRESS SIGNS ARE REQUIRED AT EACH ACCESS ROAD GATE LEADING TO THE COMPOUND AS WELL AS ON THE COMPOUND GATE ITSELF. LETTERING ON 911 ADDRESS SIGNS MUST BE A MINIMUM OF 6" TALL.
- 5. ADDITIONAL FCC REGISTRATION # SIGNS ARE REQUIRED AT EACH ACCESS ROAD GATE LEADING TO THE COMPOUND AS WELL AS ON THE COMPOUND GATE ITSELF.
- 6. RECOMMENDED SOURCE FOR OBTAINING SIGNAGE:

ST. CLAIR SIGNS 3184 WADE HAMPTON BLVD. TAYLORS, SC 29687 (864) 244-0040 RF EXPOSURE SIGNS RICHARD TELL ASSOCIATES 3433 RINGSTAR ROAD, SUITE 3 NORTH LAS VEGAS, NV 89030 (702) 645–3338 PLANS PREPARED FOR:


AMERICAN TOWER
CORPORATION

400 REGENCY FOREST DRIVE
CARY, NC 27511

PROJECT INFORMATION:

AT&T SITE #: 368-545 ATC#: 280373 MEACHAM NC

> POYTHRESS ROAD CHAPEL HILL, NC 27516 (CHATHAM COUNTY)

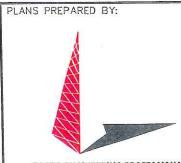

TOWER ENGINEERING PROFESSIONALS

3703 JUNCTION BOULEVARD RALEIGH, NC 27603-5263 OFFICE: (919) 661-6351 www.tepgroup.net

N.C. LICENSE # C 1794



| 07-19-13 | CONSTRUCTION | 0 05-22-13 | PRELIMINARY | REV | DATE | ISSUED FOR:

DRAWN BY: SCB CHECKED BY: GM

SHEET TITLE:

SIGNAGE DETAILS

SHEET NUMBER:


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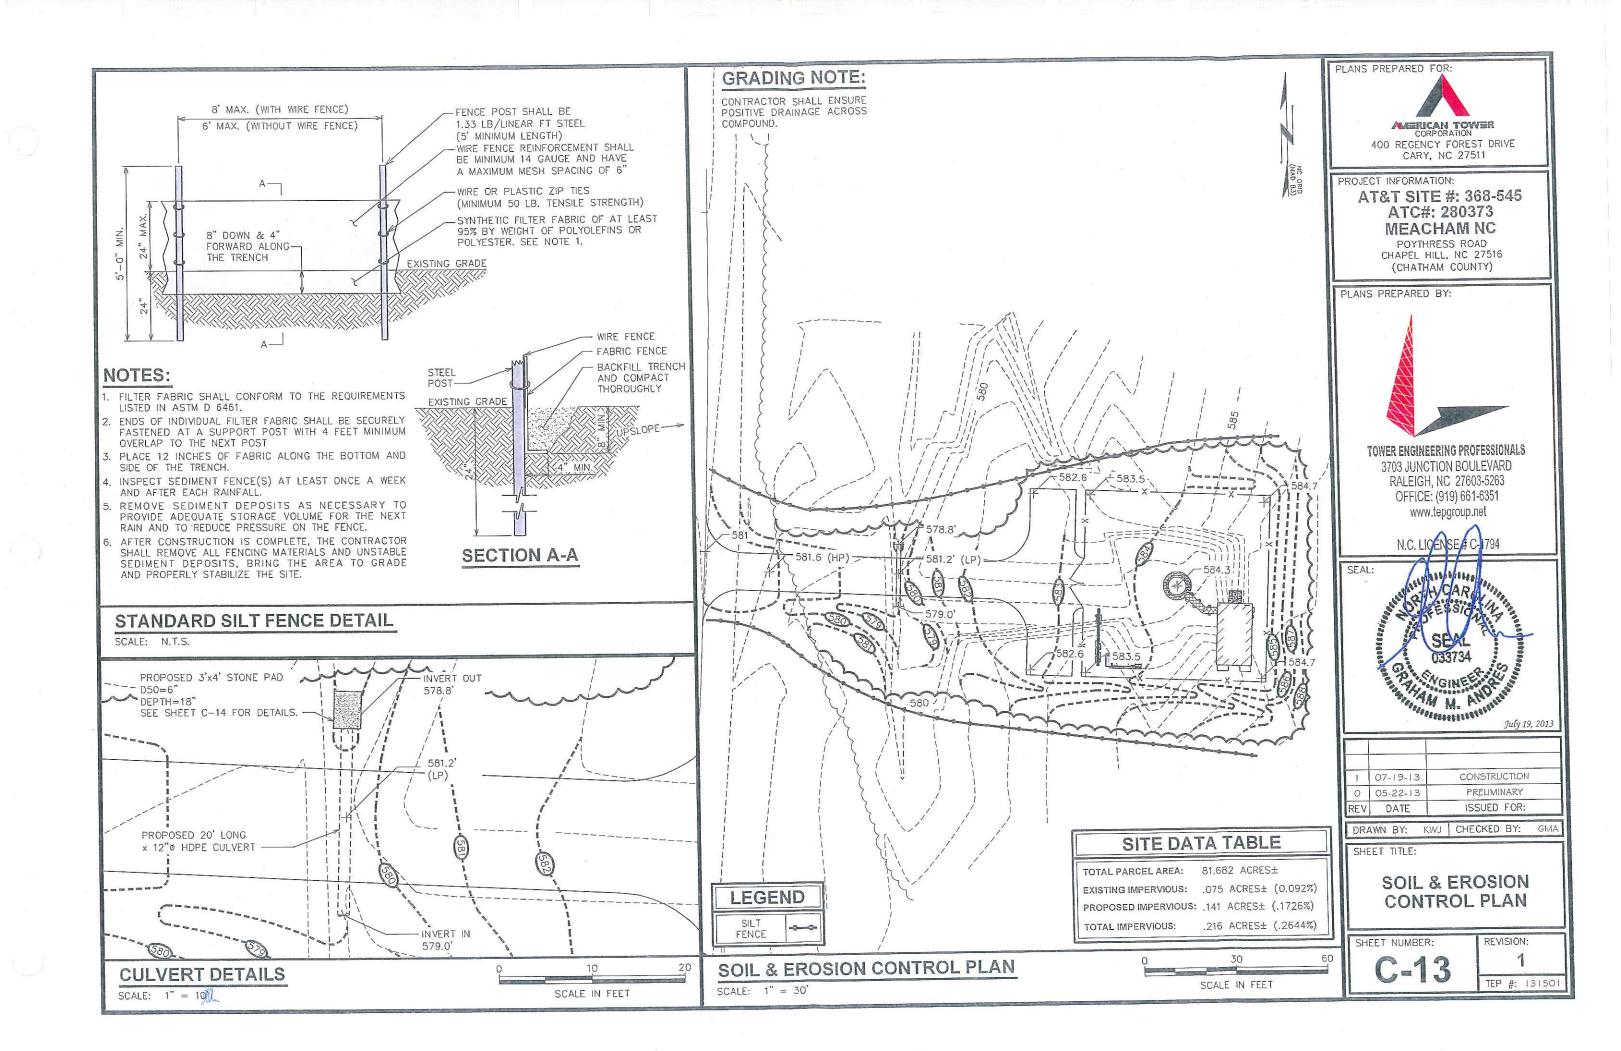
REVISION:

TEP #: 13150

TYPICAL SIGNS AND SPECIFICATIONS

SCALE: N.T.



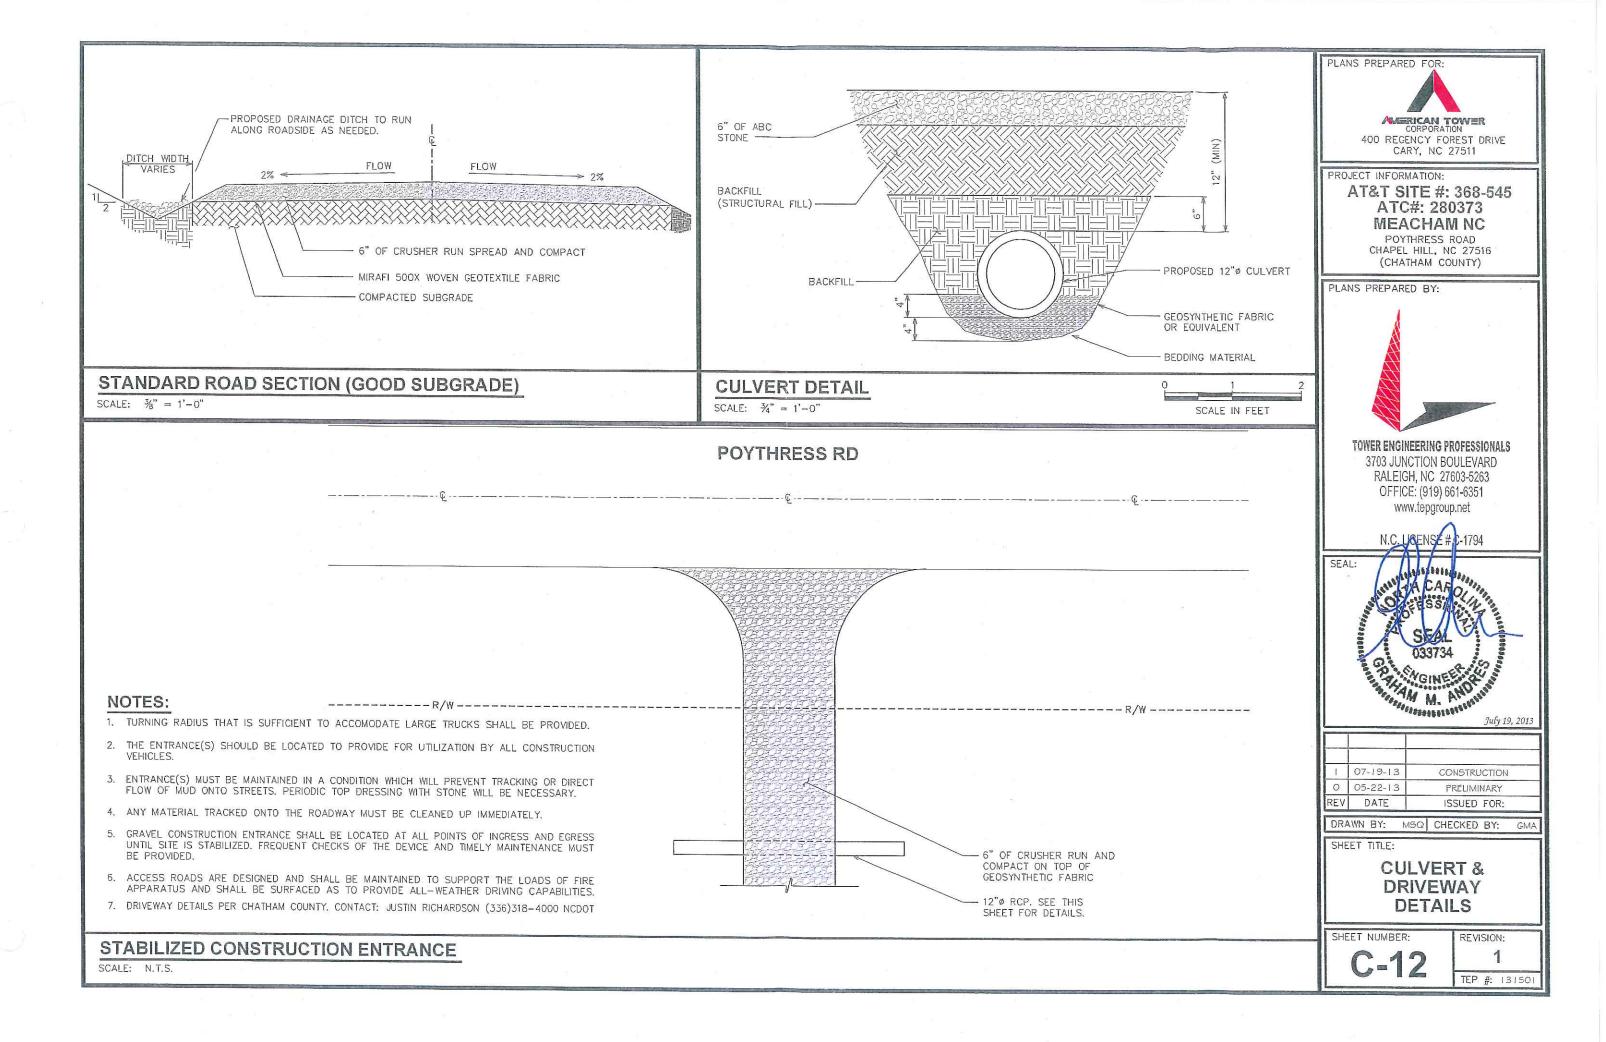

### NOTES:

- 1. L = THE LENGTH OF THE RIPRAP APRON.
- 2. d=1.5 TIMES THE MAXIMUM STONE DIAMETER BUT NOT LESS THAN 6" (INCHES).
- A FILTER BLANKET OR FILTER FABRIC SHOULD BE INSTALLED BETWEEN THE RIPRAP AND SOIL FOUNDATION.



CORPORATION
400 REGENCY FOREST DRIVE
CARY, NC 27511

PROJECT INFORMATION:

### AT&T SITE #: 368-545 ATC#: 280373 MEACHAM NC

POYTHRESS ROAD CHAPEL HILL, NC 27516 (CHATHAM COUNTY)

PLANS PREPARED BY:



### TOWER ENGINEERING PROFESSIONALS

3703 JUNCTION BOULEVARD RALEIGH, NC 27603-5263 OFFICE: (919) 661-6351 www.tepgroup.net

N.C. LICENSE # C-1794



1	07-19-13	CONSTRUCTION
0	05-22-13	PRELIMINARY
REV	DATE	ISSUED FOR:

DRAWN BY: JJC CHECKED BY: GMA

SHEET TITLE:

PIPE OUTLET PROTECTION DETAILS


SHEET NUMBER:

C-14

REVISION: 1
TEP #: 131501

PIPE FILTER FABRIC

### SECTION 'A-A'

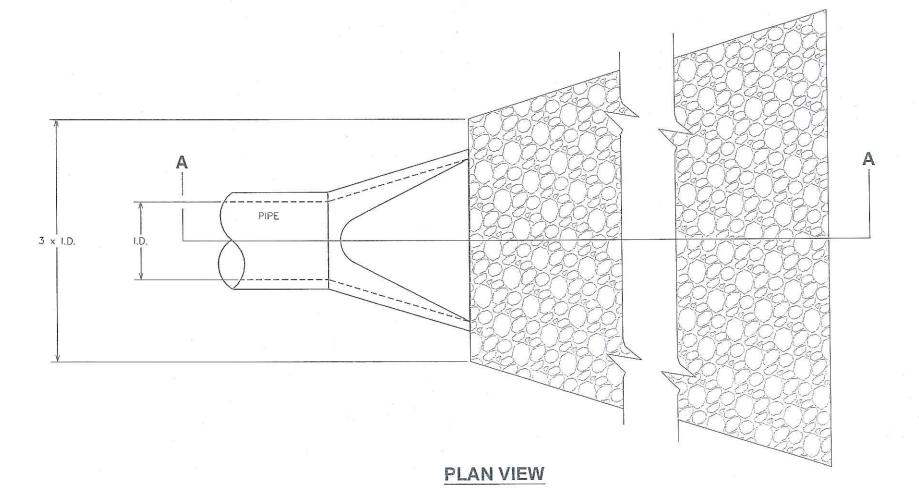

### PIPE OUTLET PROTECTION

### **ELECTRICAL NOTES:**

#### SCOPE:

- SHALL INCLUDE ALL LABOR, MATERIALS AND APPLIANCES REQUIRED FOR THE FURNISHING, INSTALLING AND TESTING, COMPLETE AND READY FOR OPERATION OF ALL WORK SHOWN ON THE DRAWING AS SPECIFIED
  - ELECTRIC SERVICE
- 4. MISCELLANEOUS MATERIALS
- 2. CONDUIT AND RACEWAY
- 5. TELEPHONE CONDUITS
- 3. CONDUCTORS
- 6. LIGHTNING ARRESTING SYSTEM

### CODES

- 1. THE INSTALLATION SHALL COMPLY WITH ALL APPLICABLE LAWS AND CODES, THESE INCLUDE BUT ARE NOT LIMITED TO THE LATEST EDITIONS OF:
  - A. THE NATIONAL ELECTRICAL SAFETY CODE B. THE NATIONAL ELECTRIC CODE - NFPA-70
- D. LOCAL AND STATE AMENDMENTS
- E. REGULATIONS OF THE SERVING UTILITY COMPANY F. NCEC
- C. THE INTERNATIONAL ELECTRIC CODE IBC
- 2. ALL PERMITS REQUIRED SHALL BE OBTAINED BY THE CONTRACTOR.
- 3. AFTER COMPLETION AND FINAL INSPECTION OF THE WORK, THE OWNER SHALL BE FURNISHED A CERTIFICATE OF COMPLETION AND APPROVAL.

1. UPON COMPLETION OF THE INSTALLATION, OPERATE AND ADJUST ALL EQUIPMENT AND SYSTEMS TO MEET SPECIFIED PERFORMANCE REQUIREMENTS. ALL TESTING SHALL BE DONE BY QUALIFIED PERSONNEL.

1. IN ADDITION TO THE GUARANTEE OF THE EQUIPMENT BY THE MANUFACTURER, EACH PIECE OF EQUIPMENT SPECIFIED HEREIN SHALL ALSO BE GUARANTEED FOR DEFECTS OF MATERIAL OR WORKMANSHIP OCCURRING DURING A PERIOD OF ONE (1) YEAR FROM FINAL ACCEPTANCE OF THE WORK BY THE OWNER. WITHOUT EXPENSE TO THE OWNER ALL WARRANTEE CERTIFICATES & GUARANTEES FURNISHED BY THE MANUFACTURERS SHALL BE TURNED OVER TO THE OWNER.

### CO-ORDINATION:

1. CONTRACTOR SHALL COORDINATE ALL WORK WITH THE POWER AND TELEPHONE COMPANIES AND SHALL COMPLY WITH ALL SERVICE REQUIREMENTS OF EACH UTILITY COMPANY.

#### **EXAMINATION OF SITE**

1. PRIOR TO BEGINNING WORK, THE CONTRACTOR SHALL VISIT THE SITE OF THE JOB AND SHALL FAMILIARIZE HIMSELF WITH ALL CONDITIONS AFFECTING THE PROPOSED ELECTRICAL INSTALLATION AND SHALL MAKE PROVISIONS AS TO THE COST THEREOF, FAILURE TO COMPLY WITH THE INTENT OF THIS PARAGRAPH WILL IN NO WAY RELIEVE THE CONTRACTOR OF PERFORMING ALL WORK NECESSARY FOR A COMPLETE AND WORKING SYSTEM OR SYSTEMS.

### CUTTING, PATCHING AND EXCAVATION:

- COORDINATION OF ALL SLEEVES, CHASES, ETC., WILL BE REQUIRED PRIOR TO THE CONSTRUCTION OF ANY PORTION OF THE WORK. ALL CUTTING AND PATCHING OF WALLS, PARTITIONS, FLOORS, AND CHASES IN CONCRETE, WOOD, STEEL OR MASONRY SHALL BE DONE AS PROVIDED ON THE DRAWINGS.
- 2. ALL NECESSARY EXCAVATIONS AND BACKFILLING INCIDENTAL TO THE WORK UNLESS SPECIFICALLY NOTED OTHERWISE ON THE DRAWING SHALL BE PROVIDED BY THIS CONTRACTOR.
- 3. SEAL ALL PENETRATION THROUGH WALL AND FLOORS WITH APPROVED GROUT.

ALL EXPOSED CONDUIT SHALL BE NEATLY INSTALLED AND RUN PARALLEL OR PERPENDICULAR TO STRUCTURAL ELEMENTS. SUPPORTS AND MOUNTING HARDWARE SHALL BE HOT DIPPED GALVANIZED STEEL.

- 1. ALL CONDUCTORS SHALL BE INSTALLED IN CONDUIT. ALL CONDUIT SHALL BE RIGID STEEL, EMT OR SCH40 PVC AS INDICATED ON THE DRAWINGS.
- 2. WHERE INSTALLED ON EXTERIORS AND EXPOSED TO DAMAGE, ALL CONDUIT SHALL BE RIGID STEEL. ALUMINUM CONDUIT SHALL NOT BE ALLOWED.
- 3. CONCEALED CONDUIT IN WALLS OR INTERIOR SPACES ABOVE GRADE MAY BE EMT.
- 4. UNDERGROUND CONDUITS SHALL BE RIGID STEEL OR SCHEDULE 40 PVC AS INDICATED ON THE DRAWINGS.
- 5. ALL CONDUIT RUNS SHALL USE APPROVED COUPLINGS AND CONNECTORS. PROVIDE INSULATED BUSHING FOR ALL CONDUIT TERMINATIONS, ALL CONDUIT RUNS IN A WET LOCATION SHALL HAVE WATERPROOF
- 6. PROVIDE SUPPORTS FOR ALL CONDUITS IN ACCORDANCE WITH NEC REQUIREMENTS. ALL CONDUITS SHALL BE SIZED AS REQUIRED BY NEC.
- 7. BURIAL DEPTH OF ALL CONDUITS SHALL BE AS REQUIRED BY CODE FOR EACH SPECIFIC CONDUIT TYPE AND APPLICATION.
- 8. CONDUIT ROUTES ARE SCHEMATIC. CONTRACTOR SHALL FIELD VERIFY BEFORE BID. COORDINATE ROUTE WITH WIRELESS CARRIER AND BUILDING OWNER.

#### EQUIPMENT:

- 1. ALL DISCONNECT SWITCHES SHALL BE SERVICE ENTRANCE RATED, HEAVY DUTY TYPE.
- 2. NEW CIRCUIT BREAKERS SHALL BE RATED TO WITHSTAND THE MAXIMUM AVAILABLE FAULT CURRENT AS DETERMINED BY THE LOCAL UTILITY. CONTRACTOR SHALL VERIFY MAXIMUM AVAILABLE FAULT CURRENT, AND COORDINATE INSTALLATION WITH THE LOCAL UTILITY BEFORE STARTING WORK.

### CONDUCTORS

- 1. FURNISH AND INSTALL CONDUCTORS CALLED FOR IN THE DRAWINGS. ALL CONDUCTORS SHALL HAVE TYPE THWN (MIN) (75°C) INSULATION, RATED FOR 600 VOLTS.
- 2. ALL CONDUCTORS SHALL BE COPPER, THE USE OF ALUMINUM CONDUCTORS SHALL NOT BE ALLOWED. ALL CONDUCTORS SHALL BE UL LISTED AND SHALL BE PROVIDED AND INSTALLED AS FOLLOWS:
  - A. MINIMUM WIRE SIZE SHALL BE #12 AWG.
  - ALL CONDUCTORS SIZE #8 AND LARGER SHALL BE STRANDED. CONDUCTORS SIZED #10 AND SMALLER MAY BE SOLID OR STRANDED.
  - CONNECTION FOR #10 AWG AND SMALLER SHALL BE BY TWISTING TIGHT AND INSTALLING INSULATED PRESSURE OR WIRE NUT CONNECTIONS.
  - D. CONNECTION FOR #8 AWG AND LARGER SHALL BE BY USE OF STEEL CRIMP-ON SLEEVES WITH NYLON INSULATOR.
- 3. ALL CONDUCTORS SHALL BE COLOR CODED IN ACCORDANCE WITH NEC STANDARDS.
- 4. THE RACEWAY SYSTEM SHALL BE COMPLETE BEFORE INSTALLING CONDUCTORS

#### PENETRATIONS:

1. CONTRACTOR SHALL COMPLY WITH UL PENETRATION DETAILS FOR PENETRATIONS OF ALL RATED WALLS, ROOF, ETC.

#### GROUNDING

- ALL ELECTRICAL NEUTRALS, RACEWAYS AND NON-CURRENT CARRYING PARTS OF ELECTRICAL EQUIPMENT AND ASSOCIATED ENCLOSURES SHALL BE GROUNDED IN ACCORDANCE WITH NEC ARTICLE 250. THIS SHALL INCLUDE NEUTRAL CONDUCTORS, CONDUITS, SUPPORTS, CABINETS, BOXES, GROUND BUSSES, ETC. THE NEUTRAL CONDUCTOR FOR EACH SYSTEM SHALL BE GROUNDED BY ONE POINT ONLY.
- 2. PROVIDE GROUND CONDUCTOR IN ALL RACEWAYS.
- 3. PROVIDE BONDING AND GROUND TO MEET NFPA 780 LIGHTNING PROTECTION AS A MINIMUM.
- 4. PROVIDE GROUNDING SYSTEM AS INDICATED ON THE DRAWINGS, AS REQUIRED BY THE NATIONAL ELECTRIC CODE AND RADIO EQUIPMENT MANUFACTURER.

### ABBREVIATIONS AND LEGEND

 AMPFRE - ABOVE FINISHED GRADE

AUTOMATIC TRANSFER SWITCH

- AMERICAN WIRE GAUGE AWG

 BARE COPPER WIRE BELOW FINISHED GRADE

BKR BREAKER CONDUIT

CKT - CIRCUIT

DISCONNECT

 EXTERNAL GROUND RING ELECTRIC METALLIC TUBING

- FLEXIBLE STEEL CONDUIT

 GENERATOR GEN

**GPS** - GLOBAL POSITIONING SYSTEM

GRD - GROUND

**IGB** ISOLATED GROUND BAR

- INTERIOR GROUND RING (HALO) IGR

KILOWATTS

NATIONAL ELECTRIC CODE

PERSONAL COMMUNICATION SYSTEM

 PHASE PNL - PANEL

PNLBD - PANELBOARD

SCH40 RIGID NON-METALLIC CONDUIT

 RIGID GALVANIZED STEEL CONDUIT SW

TGB TOWER GROUND BAR

UNDERWRITERS LABORATORIES

 VOLTAGE WATTS

X

XFMR - TRANSFORMER

XMTR - TRANSMITTER

--E---- UNDERGROUND ELECTRICAL CONDUIT ----T---- UNDERGROUND TELEPHONE CONDUIT KILOWATT-HOUR METER UNDERGROUND BONDING AND GROUNDING CONDUCTOR. Ø GROUND ROD CADWELD

GROUND ROD WITH INSPECTION WELL

PLANS PREPARED FOR:

CORPORATION 400 RECENCY FOREST DRIVE CARY, NC 27511

PROJECT INFORMATION:

### AT&T SITE #: 368-545 ATC#: 280373 MEACHAM NC

POYTHRESS ROAD CHAPEL HILL, NC 27516 (CHATHAM COUNTY)

PLANS PREPARED BY:



TOWER ENGINEERING PROFESSIONALS 3703 JUNCTION BOULEVARD

RALEIGH, NC 27603-5263 OFFICE: (919) 661-6351 www.tepgroup.net

N.C. LICENSE # C-1794



July 19, 2013

07-19-13 CONSTRUCTION 0 05-22-13 PRELIMINARY ISSUED FOR: DATE

DRAWN BY: 5CB | CHECKED BY:


SHEET TITLE:

**ELECTRICAL** NOTES

SHEET NUMBER

REVISION

TEP #: 13150

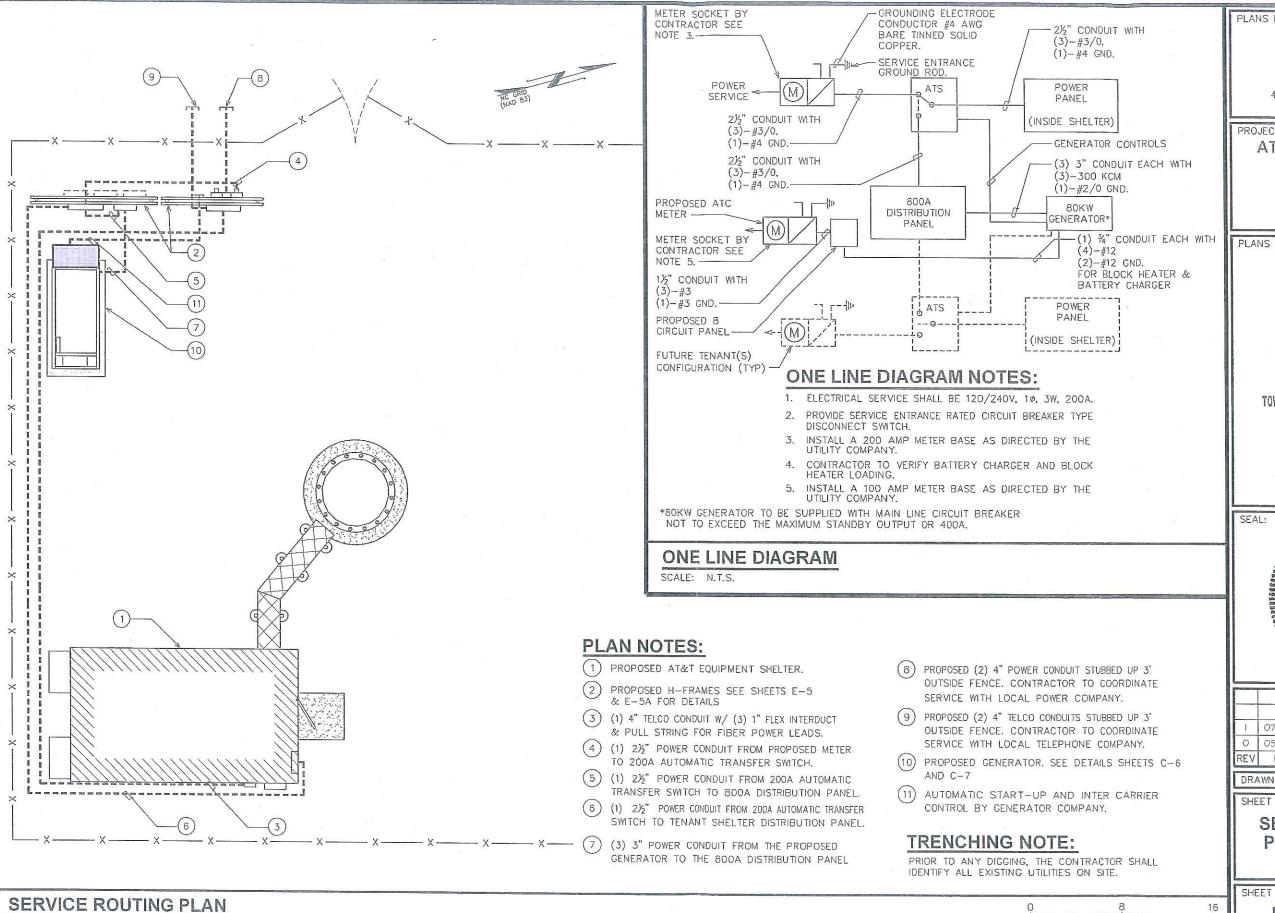

SCALE:  $\frac{1}{2}$ " = 1'-0"

PLANS PREPARED FOR:



AMERICAN TOWER

400 REGENCY FOREST DRIVE CARY, NC 27511

PROJECT INFORMATION:

### AT&T SITE #: 368-545 ATC#: 280373 MEACHAM NC

POYTHRESS ROAD CHAPEL HILL, NC 27516 (CHATHAM COUNTY)

PLANS PREPARED BY:



### TOWER ENGINEERING PROFESSIONALS

3703 JUNCTION BOULEVARD RALEIGH, NC 27603-5263 OFFICE: (919) 661-6351 www.tepgroup.net

N.C. LICENSE # C-1794

FRICK Time July 19, 2013

1	07-19-13	CONSTRUCTION
0	05-22-13	PRELIMINARY
REV	DATE	ISSUED FOR:

DRAWN BY: CSN CHECKED BY:


SHEET TITLE:

SERVICE ROUTING PLAN & ONE-LINE DIAGRAM

SHEET NUMBER:

SCALE IN FEET


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AT&T POWER PANEL SCHEDULE	VOLT AMPERES WIRE BREAKER CKT PHASE CKT BREAKER WRE VOLT AMPERES LOAD SERVED	P TRIP #	(	3400	35 12 1 15 5 A A 6 70 9 19 800 RECTIFIER #2	800	60 12 1 20 9 A 10 30 3 19 800 RECTIFIER #3	800	13 A A 14	800	17 A 18	19 D B C 20	21 A 22 ·	23 B 24	(		29 A A 30	395 5430 S800 S800 VOLT AMPS	L1 VOLT AMPERES 10695 11230 L2 VOLT AMPERES	21925 TOTAL VOLT AMPERES	91.35 TOTAL AMPS	114.19 AMPS X 125%	125.61 X 110% FOR MAIN	
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							16.04		X 110% FOR MAIN	JR MAIN				

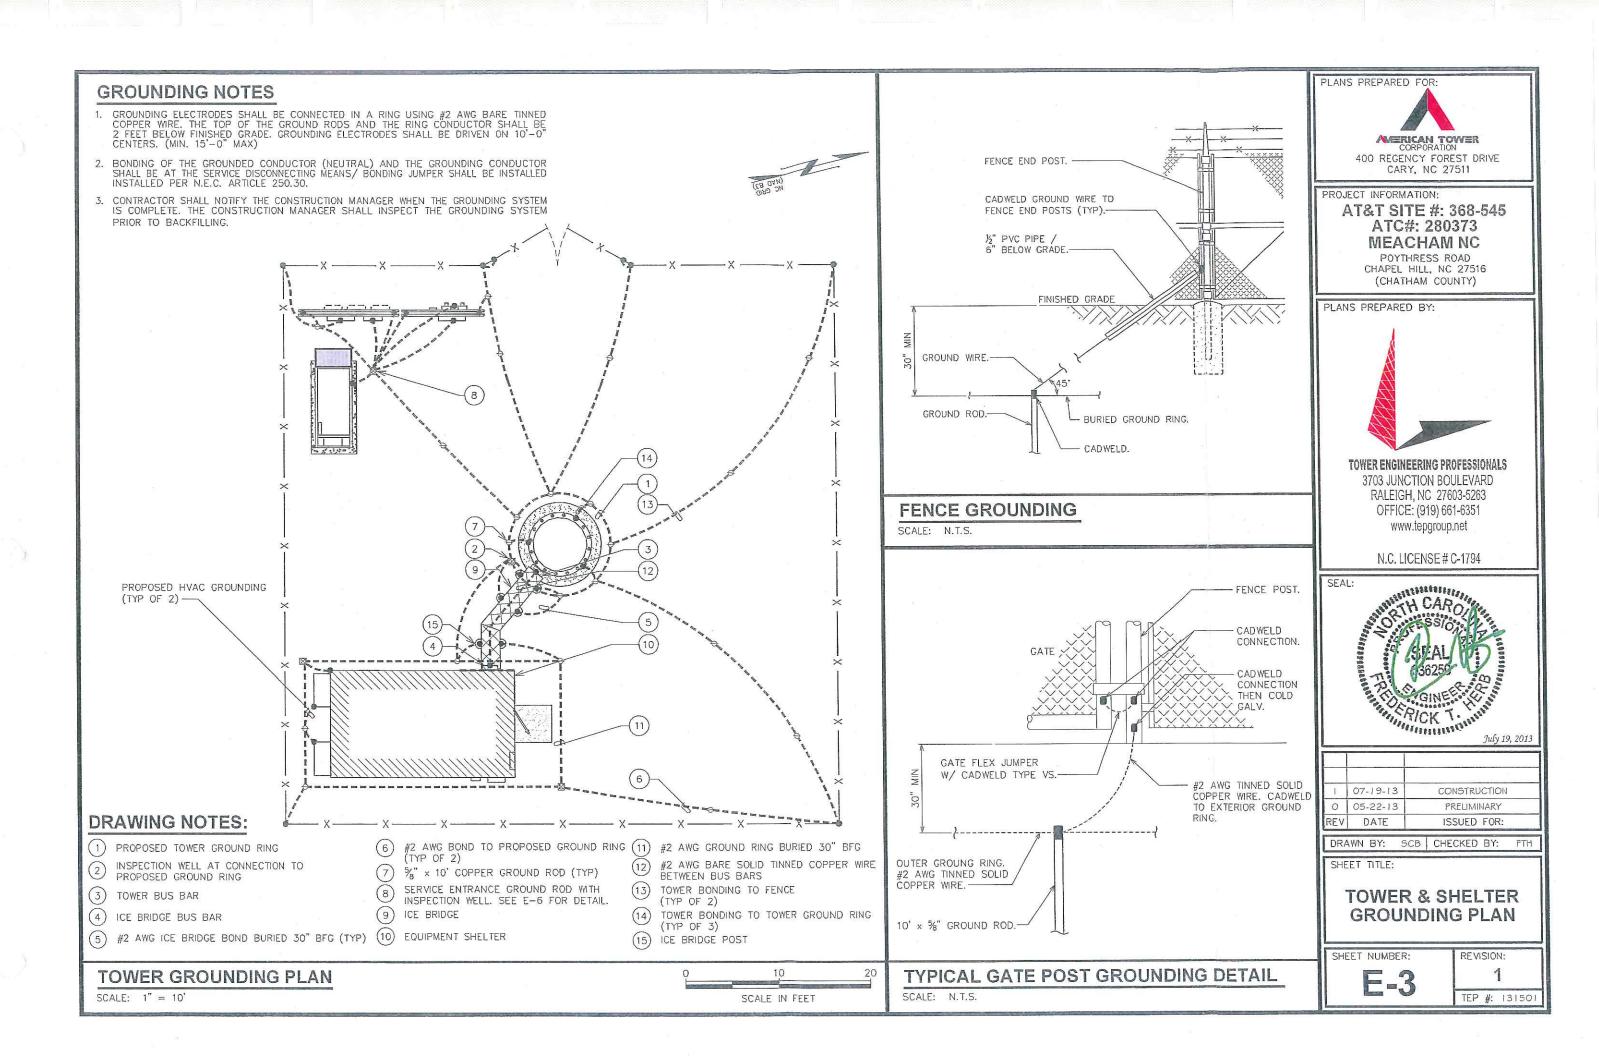

N.C. LICENSE # C-1794 SEAL: William CAD A Community July 19, 2013

TOWER ENGINEERING PROFESSIONALS 3703 JUNCTION BOULEVARD RALEIGH, NC 27603-5263 OFFICE: (919) 661-6351 www.tepgroup.net

PRELIMINARY 0 05-22-13 REV DATE ISSUED FOR: DRAWN BY: CSN CHECKED BY: FTH

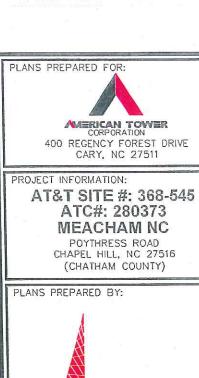CONSTRUCTION

SHEET TITLE:

07-19-13

PANELBOARD SCHEDULE

SHEET NUMBER:

E-4

REVISION: TEP #: 131501



1. ELECTRIC SERVICE: 240/120V, 1ø, 3W, 800A UNDERGROUND SERVICE TO POLE RISER.

SQUARE "D" MP METER-PAK BRANCH UNIT PART #MP86200

SCALE: N.T.S.

- 2. USE COPPER STRANDED, 600V, TYPE THW/THWN, WITH CROSS-LINKED POLYETHYLENE INSULATION FOR #8 AWG AND LARGER WIRE.
- 3. UNDERGROUND CONDUITS SHALL BE SCHEDULE 40 PVC (MEET UL STANDARDS G51 AND NEMA TC2-1990). EXPOSED CONDUITS SHALL BE PVC UV RESISTANT OR RIGID GALVANIZED STEEL. ALL CONDUIT BENDS SHALL BE A MINIMUM OF 36" RADIUS.

8 CIRCUIT NEMA-3

END CAP. -

PANEL W/ 1-30 AMP 1 POLE CIRCUIT BREAKER

4. GROUNDING CONDUCTOR SHALL BE 2 AWG SOLID BARE TINNED COPPER UNLESS OTHERWISE NOTED.

5. 4" PVC CONDUIT INSTALLED 30' (MINIMUM) BELOW GRADE FOR INCOMING SERVICE BY TELEPHONE COMPANY. PROVIDE PULL STRING - 200 LB. TEST POLYETHYLENE CORD.

AMERICAN TOWER
CORPORATION 400 REGENCY FOREST DRIVE


CARY, NC 27511

PROJECT INFORMATION:

PLANS PREPARED FOR:

### AT&T SITE #: 368-545 ATC#: 280373 MEACHAM NC

POYTHRESS ROAD CHAPEL HILL, NC 27516 (CHATHAM COUNTY)

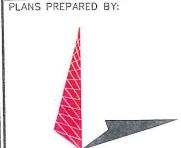

### TOWER ENGINEERING PROFESSIONALS

3703 JUNCTION BOULEVARD RALEIGH, NC 27603-5263 OFFICE: (919) 661-6351 www.tepgroup.net

N.C. LICENSE # C-1794

SEAL: July 19, 2013

CONSTRUCTION 07-19-13 05-22-13 PRELIMINARY REV DATE ISSUED FOR:


DRAWN BY: CSN CHECKED BY:

SERVICE RACK **DETAILS I** 

SHEET NUMBER:


TEP #: 13150

REVISION:

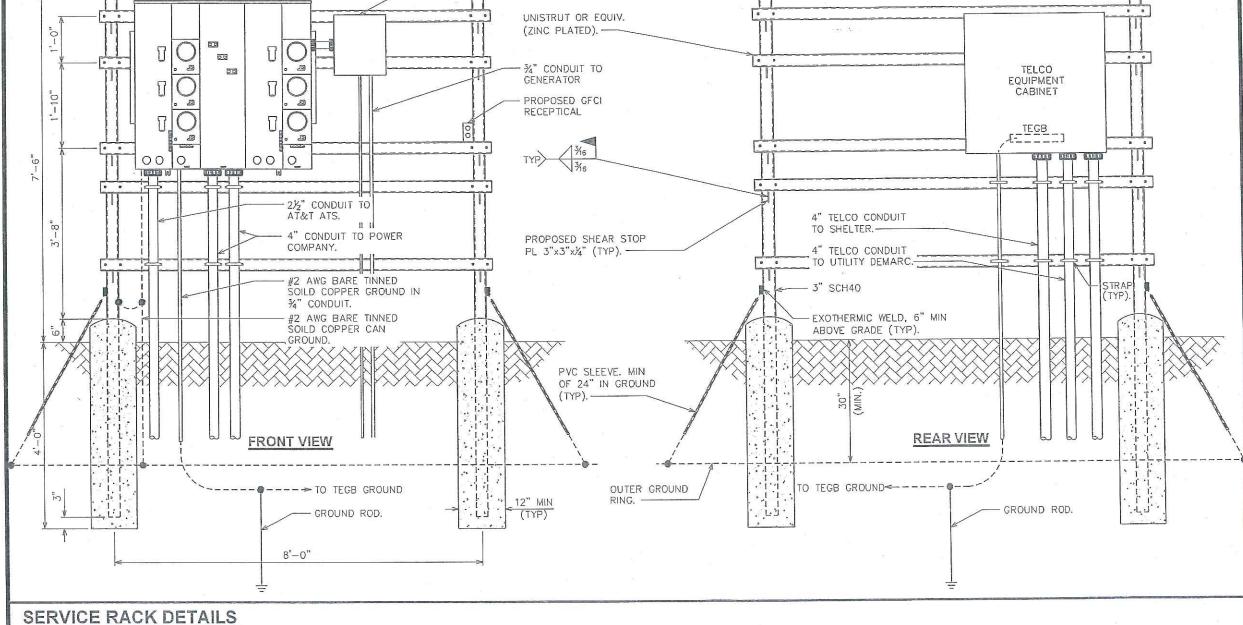

### NOTE:

SEE SHEET E-5 FOR SERVICE RACK NOTES.

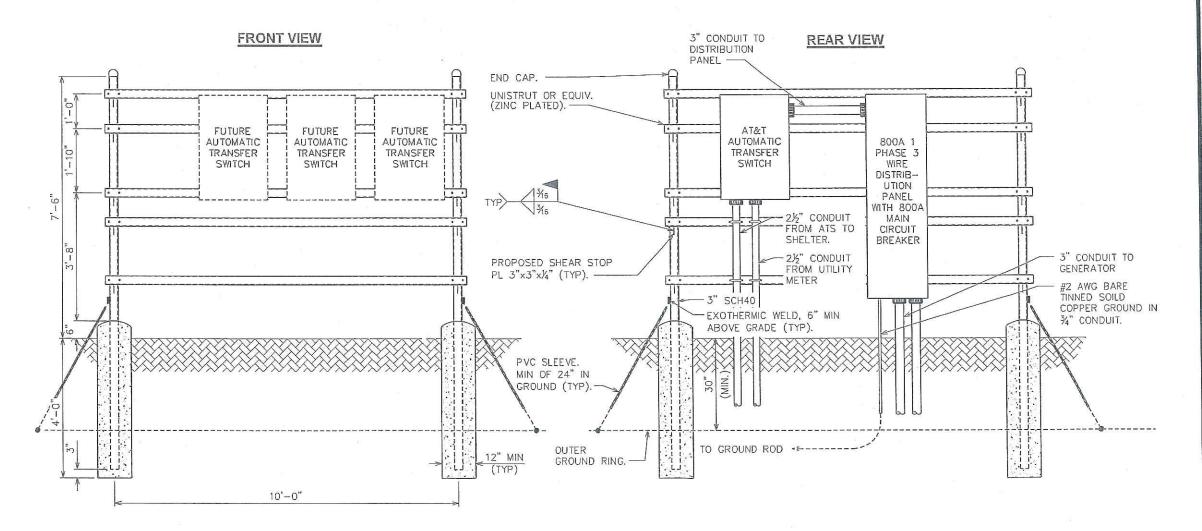

PLANS PREPARED FOR:

MERICAN TOWER
CORPORATION

400 REGENCY FOREST DRIVE

PROJECT INFORMATION:

### AT&T SITE #: 368-545 ATC#: 280373 MEACHAM NC

CARY, NC 27511

POYTHRESS ROAD CHAPEL HILL, NC 27516 (CHATHAM COUNTY)

PLANS PREPARED BY:



### TOWER ENGINEERING PROFESSIONALS

3703 JUNCTION BOULEVARD RALEIGH, NC 27603-5263 OFFICE: (919) 661-6351 www.tepgroup.net

N.C. LICENSE # C-1794



I 07-19-13 CONSTRUCTION
O 05-22-13 PRELIMINARY
REV DATE ISSUED FOR:

DRAWN BY: CSN CHECKED BY: FT

SHEET TITLE:

SERVICE RACK DETAILS II


SHEET NUMBER:


E-5A

TEP #: 13150

SERVICE RACK DETAILS


SCALE: N.T.S.

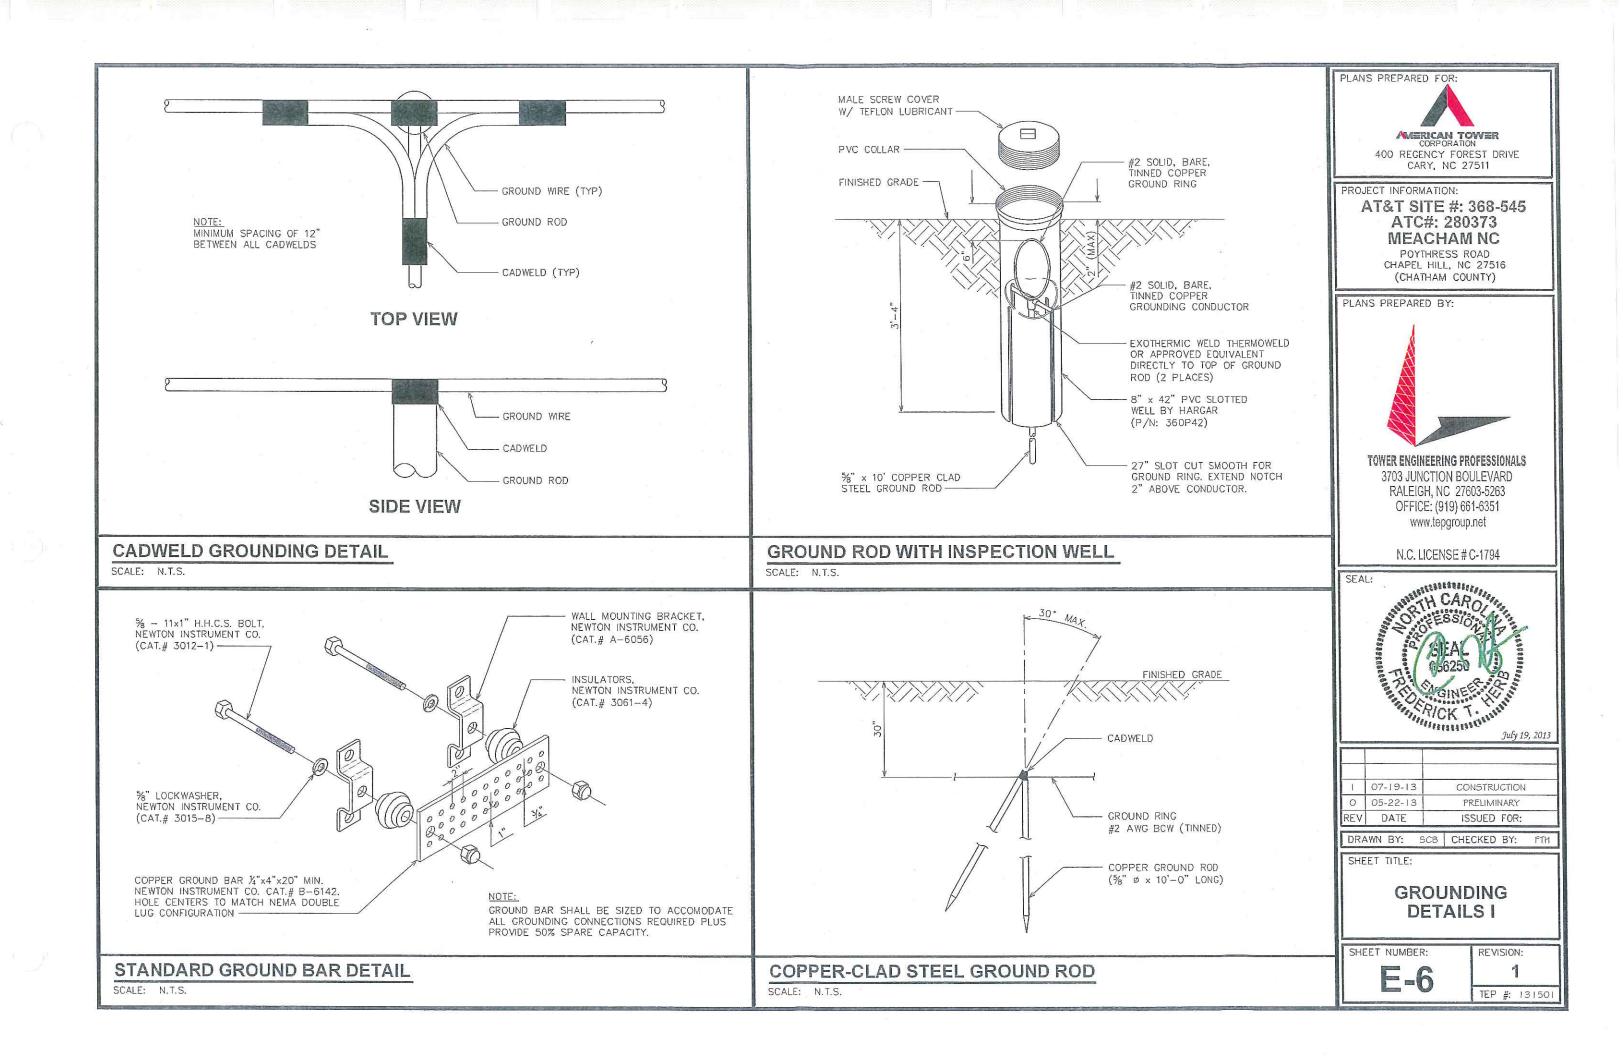


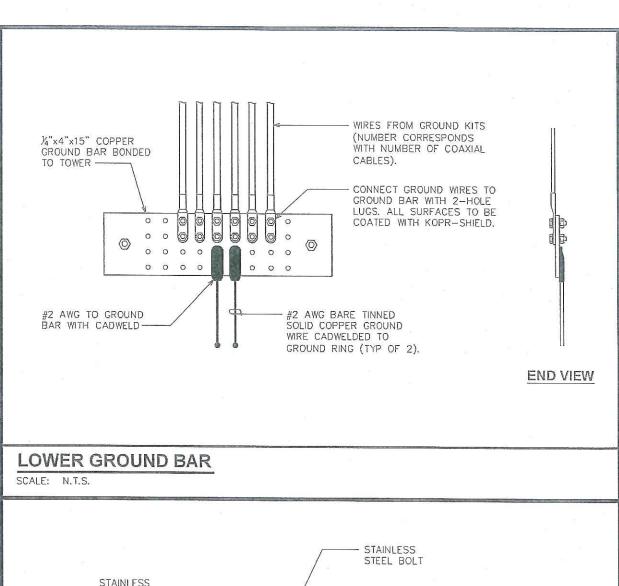

### NOTE:

THE CONTRACTOR SHALL UTILIZE AN INTERMEDIATE GROUND BAR FOR ANTENNA RAD CENTERS OVER 200'.

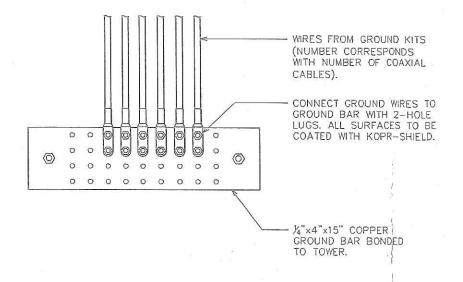

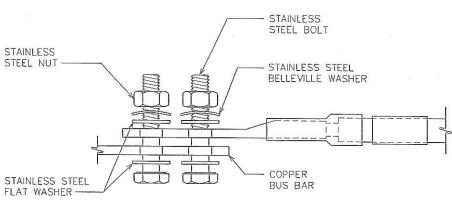


### NOTES:

- 1. ALL HARDWARE SHALL BE 18-8 STAINLESS STEEL, INCLUDING THE BELLEVILLE WASHERS. COAT ALL SURFACES WITH KOPR-SHIELD BEFORE MATING.
- 2. FOR GROUND BOND TO STEEL ONLY; INSERT A DRAGON TOOTH WASHER BETWEEN THE LUG AND STEEL. COAT ALL SURFACES WITH KOPR—SHIELD.

### UPPER / INTERMEDIATE GROUND BAR

SCALE: N.T.S.

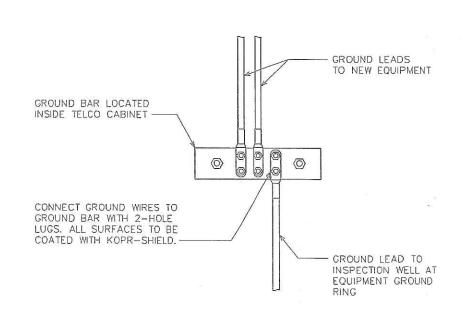

## **GROUND BAR IN TELCO CABINET**

PLANS PREPARED FOR:




400 REGENCY FOREST DRIVE CARY, NC 27511

PROJECT INFORMATION:

AT&T SITE #: 368-545 ATC#: 280373 MEACHAM NC

POYTHRESS ROAD CHAPEL HILL, NC 27516 (CHATHAM COUNTY)

PLANS PREPARED BY:

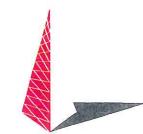

### TOWER ENGINEERING PROFESSIONALS

3703 JUNCTION BOULEVARD RALEIGH, NC 27603-5263 OFFICE: (919) 661-6351 www.tepgroup.net

N.C. LICENSE # C-1794



July 19, 2013

1	07-19-13	CONSTRUCTION
0	05-22-13	PRELIMINARY
REV	DATE	ISSUED FOR:

DRAWN BY: 5CB CHECKED BY:

SHEET TITLE:

GROUNDING **DETAILS II** 

SHEET NUMBER:

**上** 

REVISION:

TEP #: 13150

### LUG DETAIL

SCALE: N.T.S.