JORDAN LAKE DETAILING CENTER

SHEET INDEX

SHEET 1 C1 - COVER SHEET

SHEET 2 EX1 - EXISTING CONDITIONS


SHEET 3 SP1 - SITE PLAN

SHEET 4 GR1 -GRADING AND UTILITY AND EROSION CONTROL PLAN

SHEET 5 LP1 - PLANTING AND LIGHTING PLAN

SHEET 6 D1 - DETAILS SHEET 7 D2 - DETAILS

SHEET 8 D3 - DETAILS

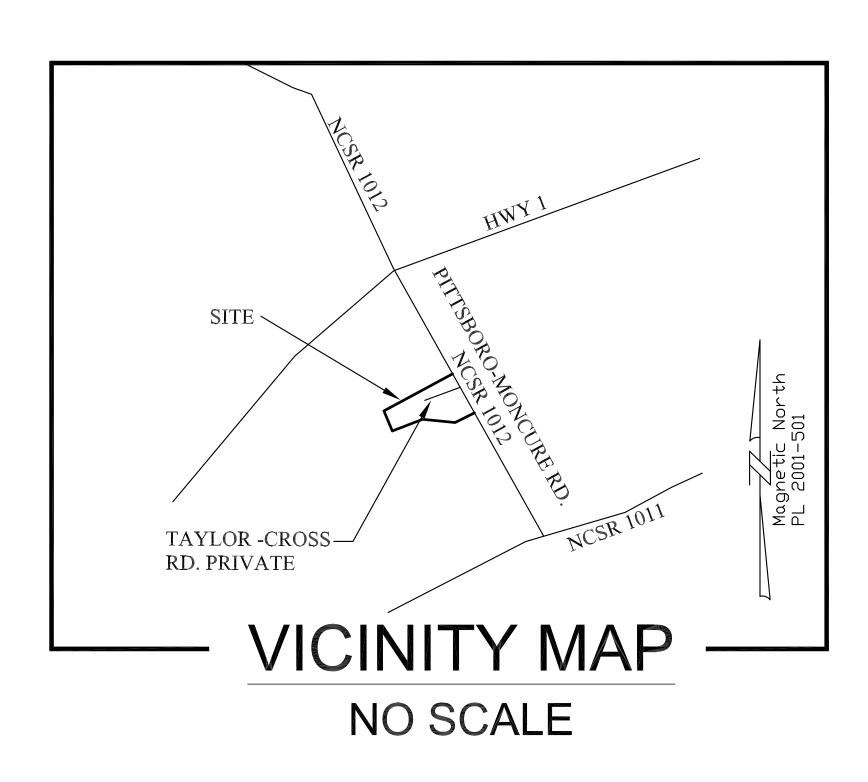

ENGINEERING FIRM:

PLANS PREPARED BY: VETERAN ENGINEERING ASSOCIATES, INC. (C-3527)

ADDRESS: P.O. BOX 1625 DURHAM, NC 27702

(919) 201–2175 PHONE:

ATTN: Thomas Ray KAGARISE, P.E., as President

<u>DEVELOPER</u> DERRY SMITH JR. ADDRESS: PO BOX 311


PHONE:


MONCURE, NC 27559 (919) 548-0802


PRELIMINARY DRAWING NOT RELEASED FOR CONSTRUCTION 6/4/12





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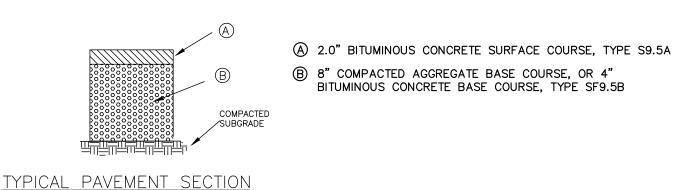
NOTES:

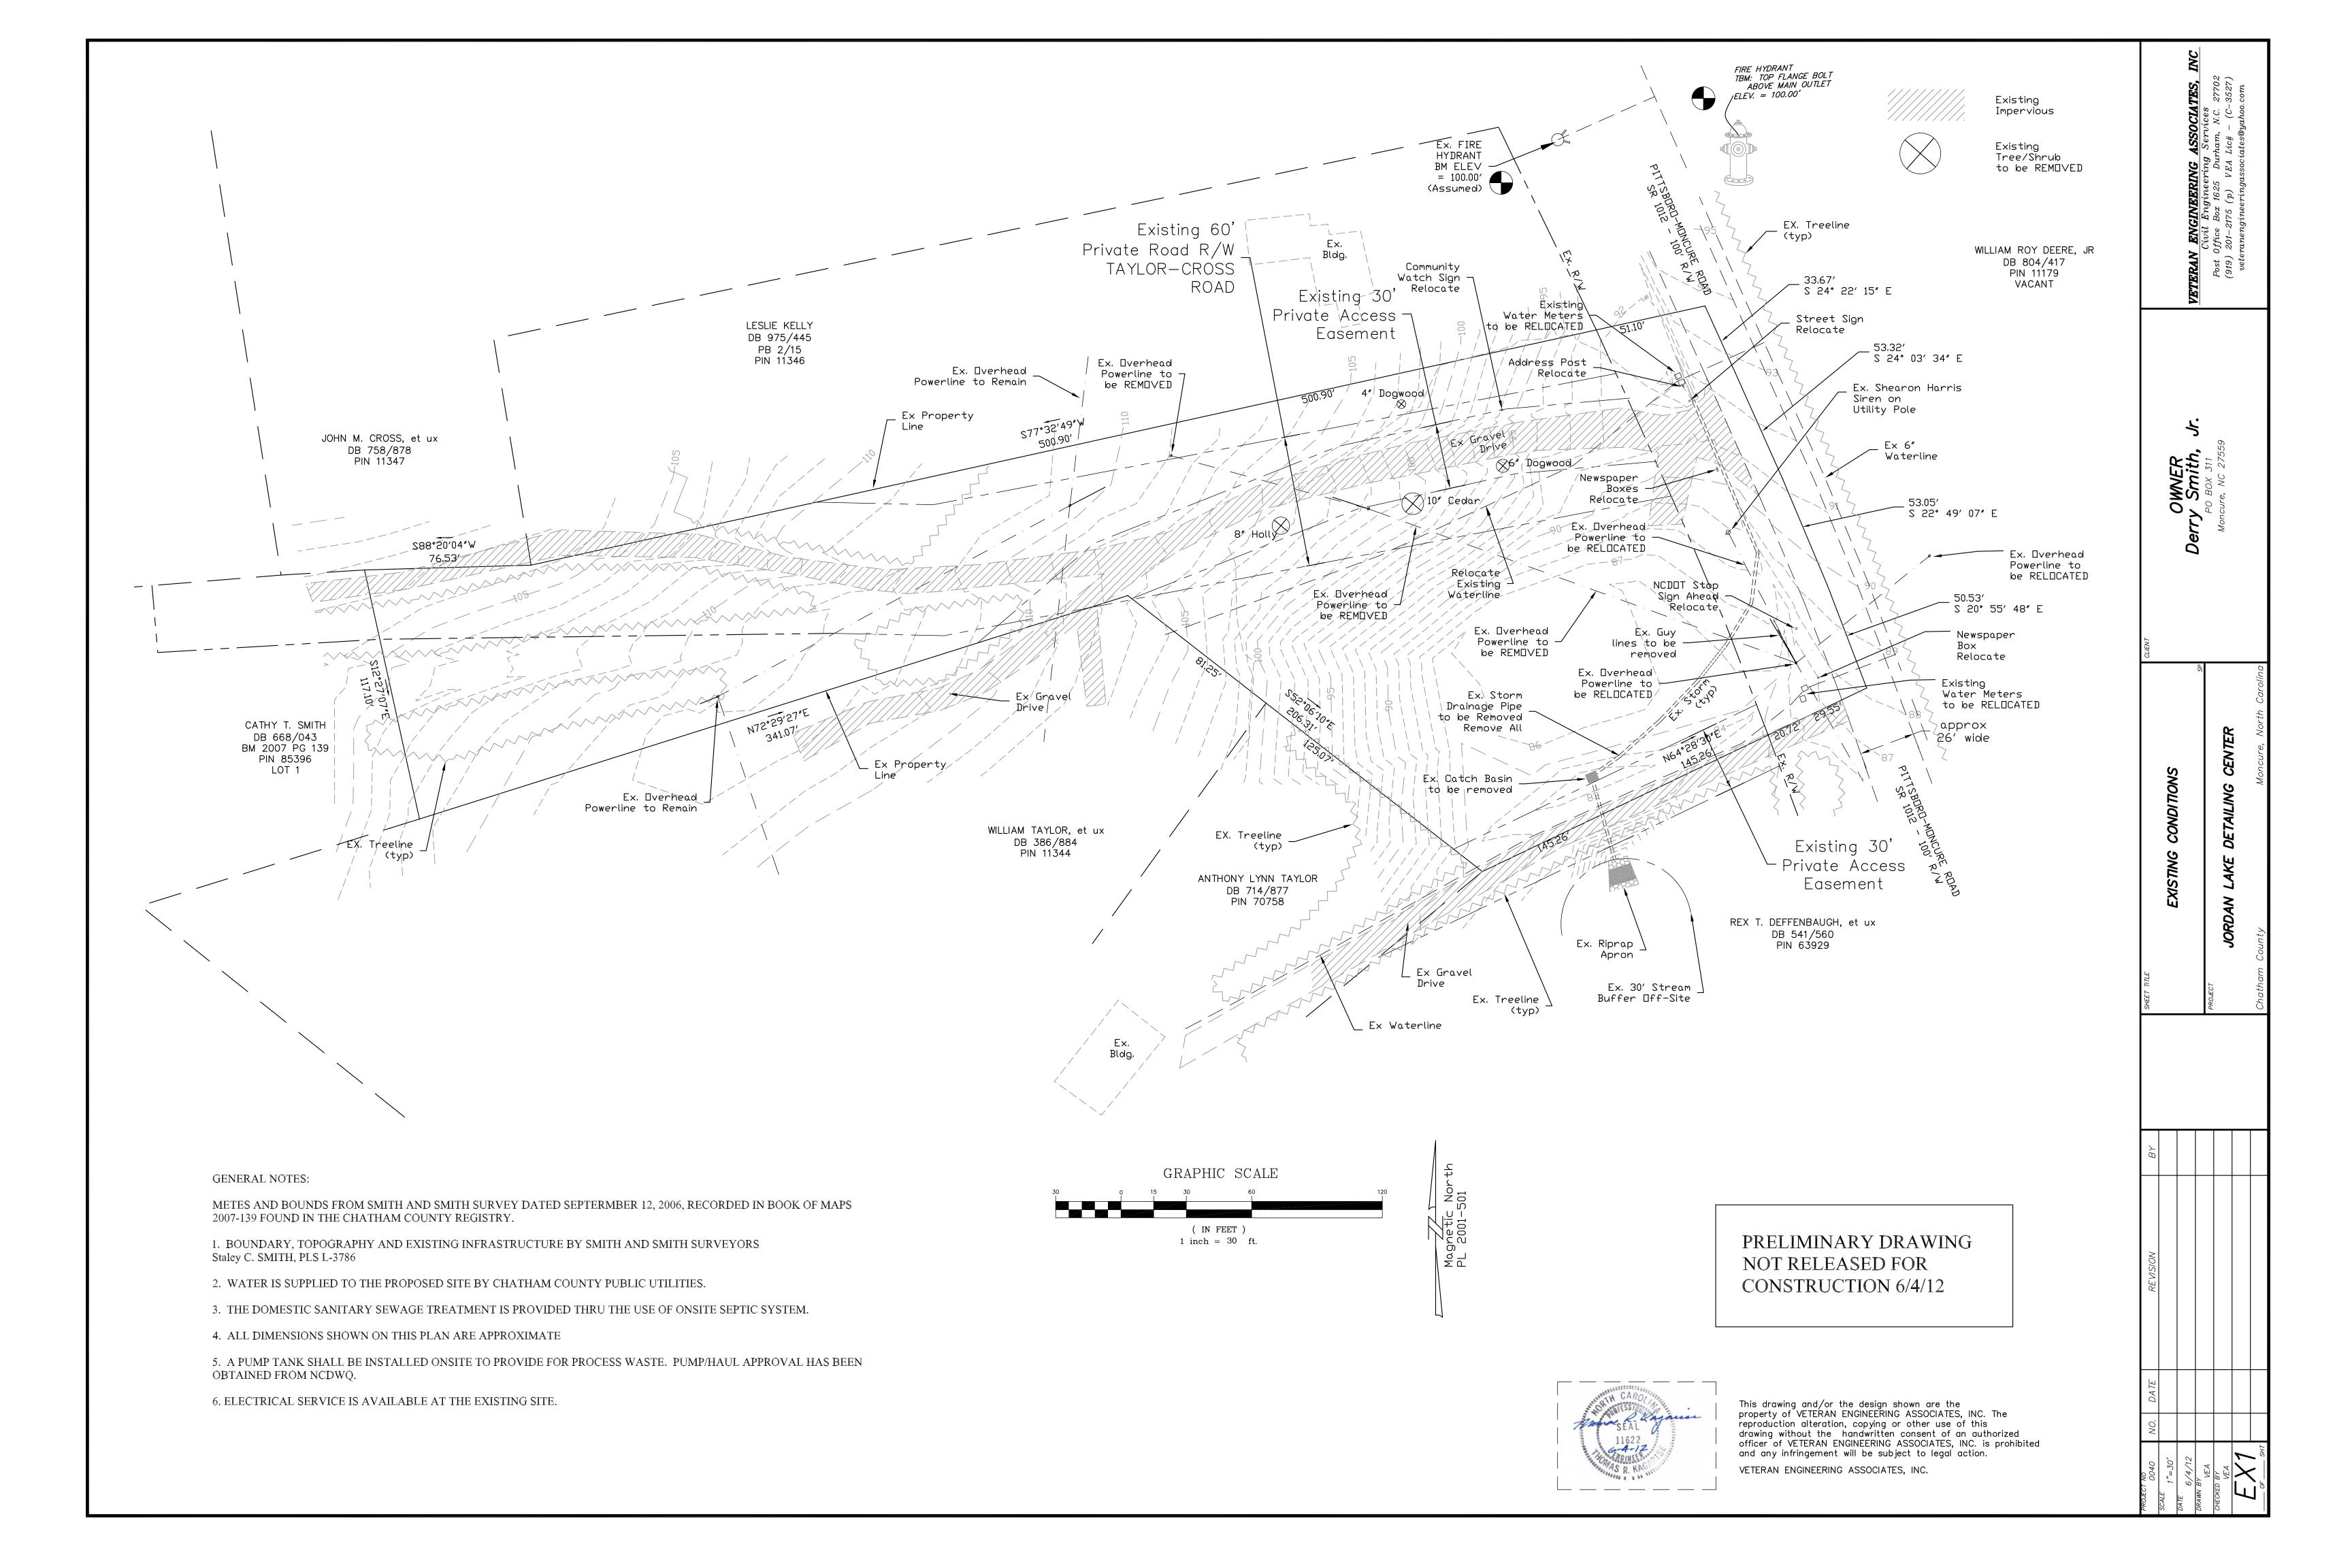- 1. ALL CONCRETE 3000 PSI. 2. ALL SIDEWALKS SHALL BE
- 1/4" EDGE RADIUS. BROOM FINISH PER COUNTY OF CHATHAM CURRENT

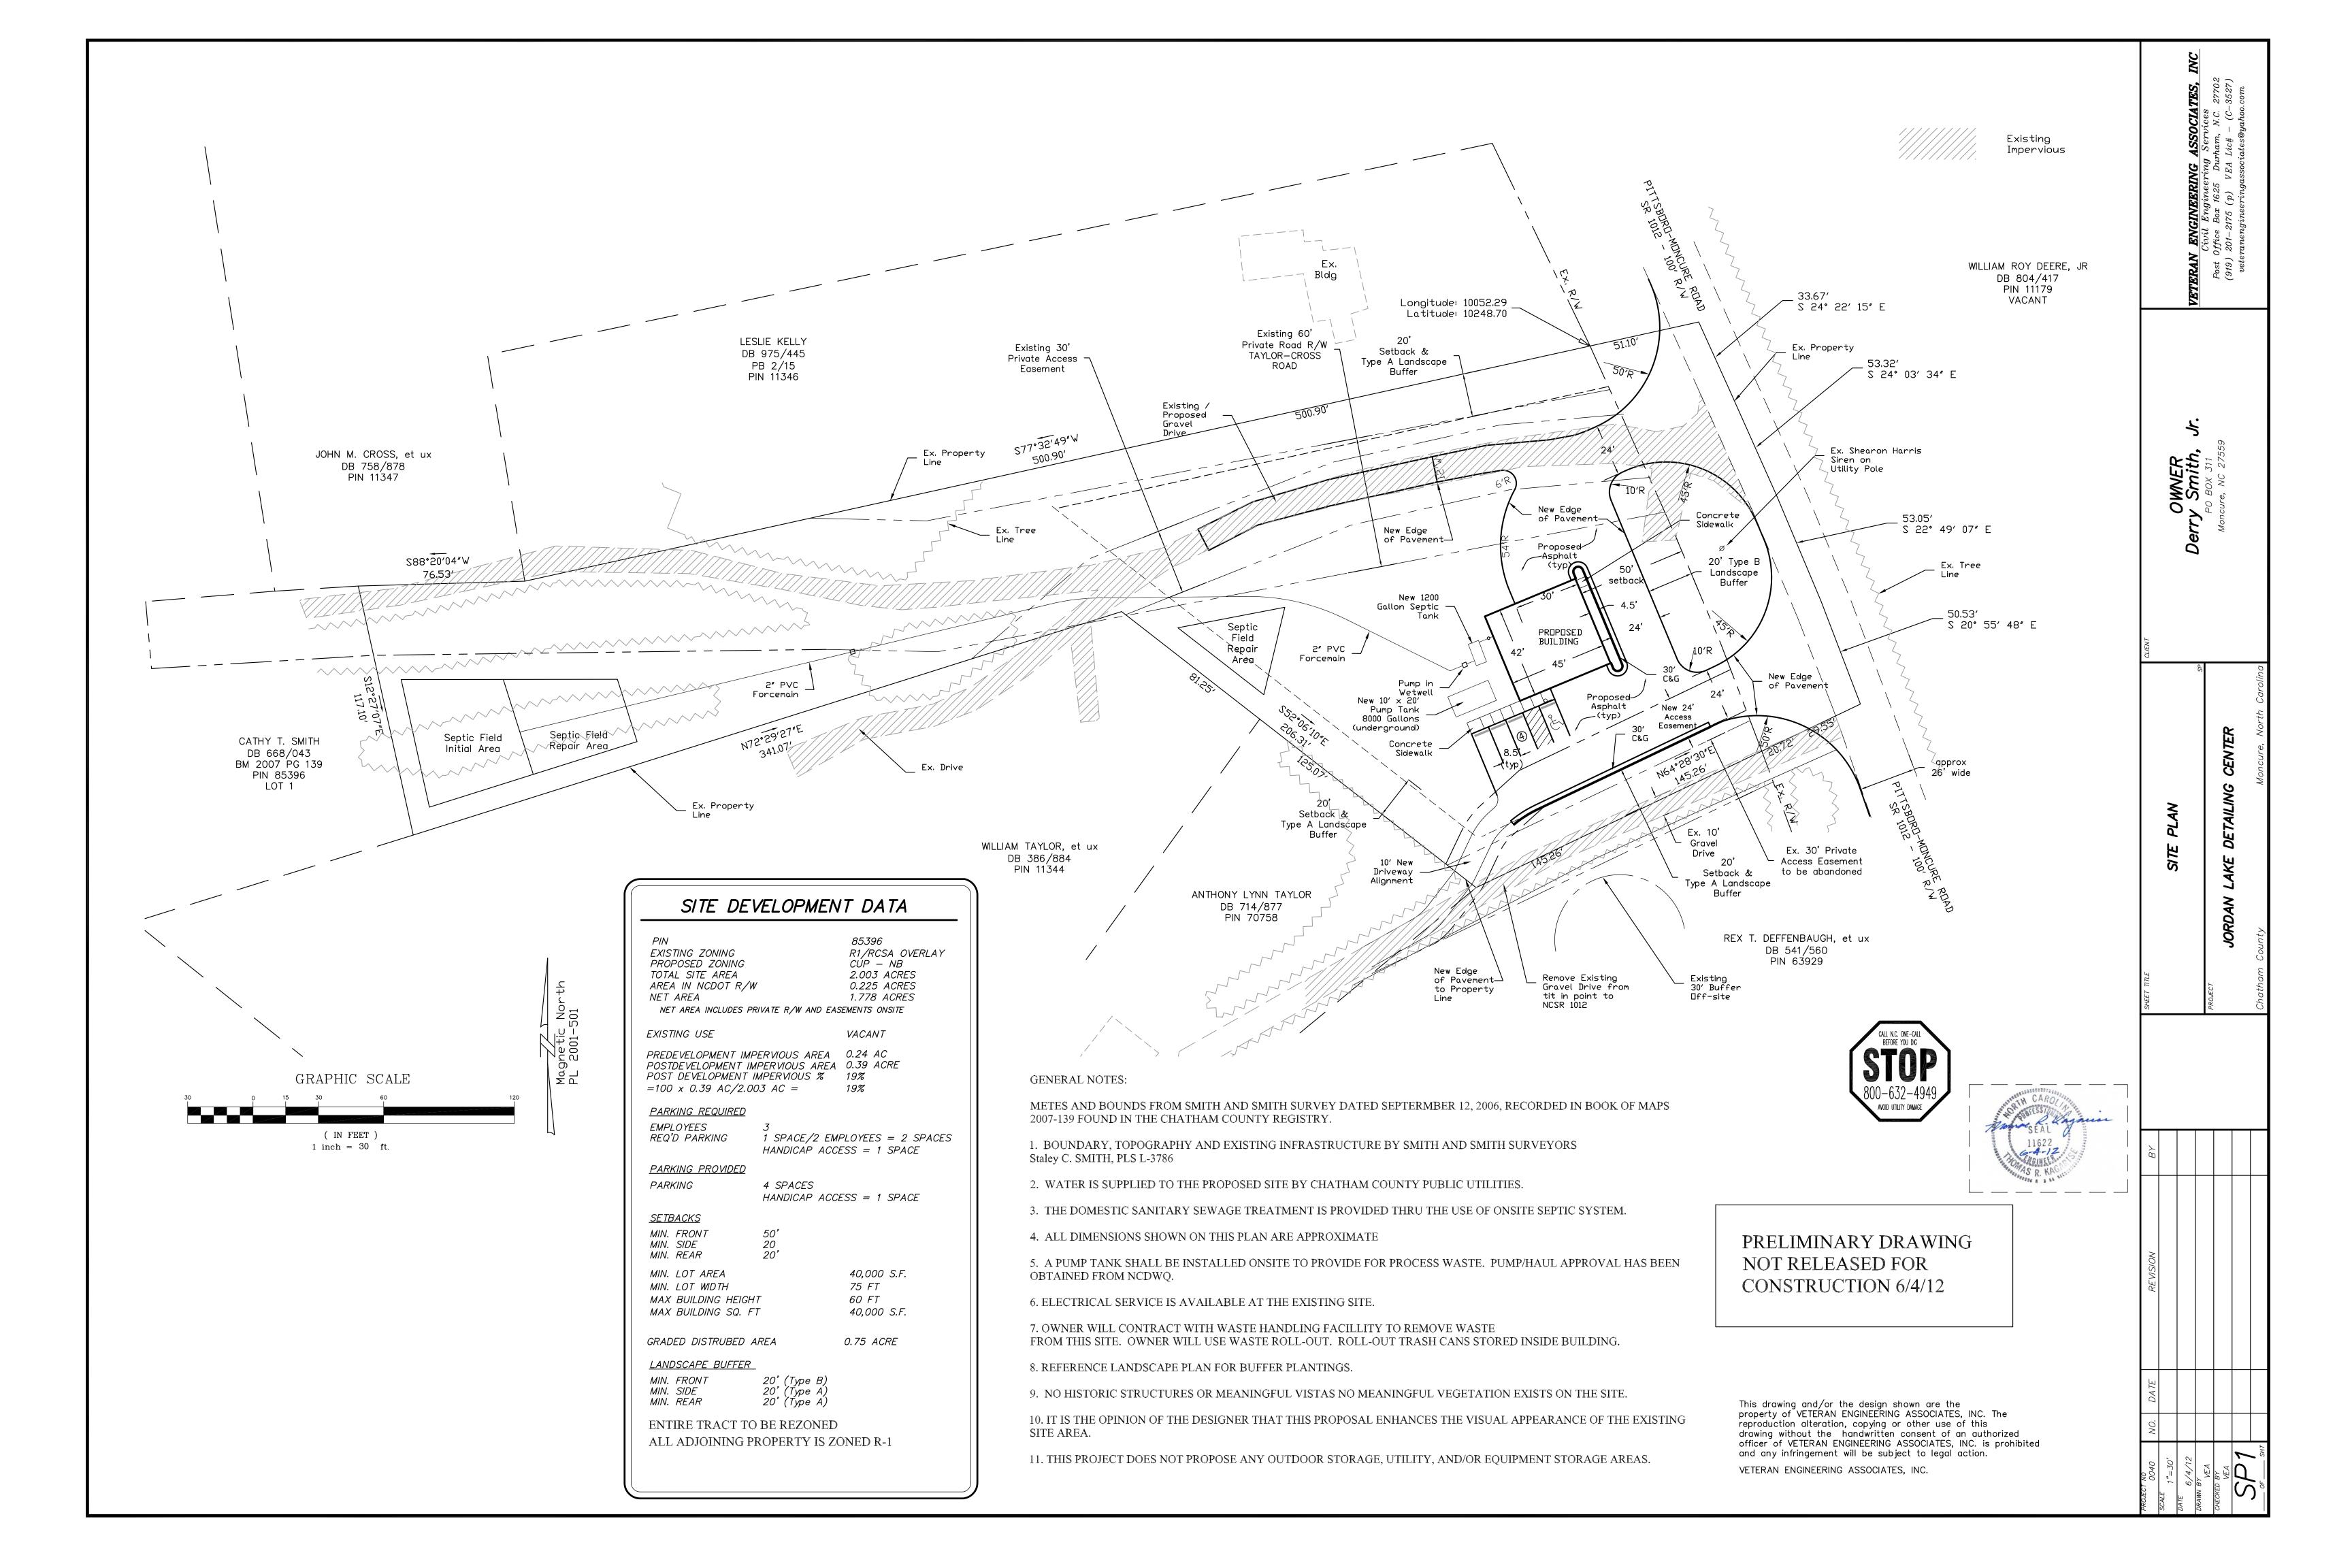STANDARDS AND SPECIFICATIONS

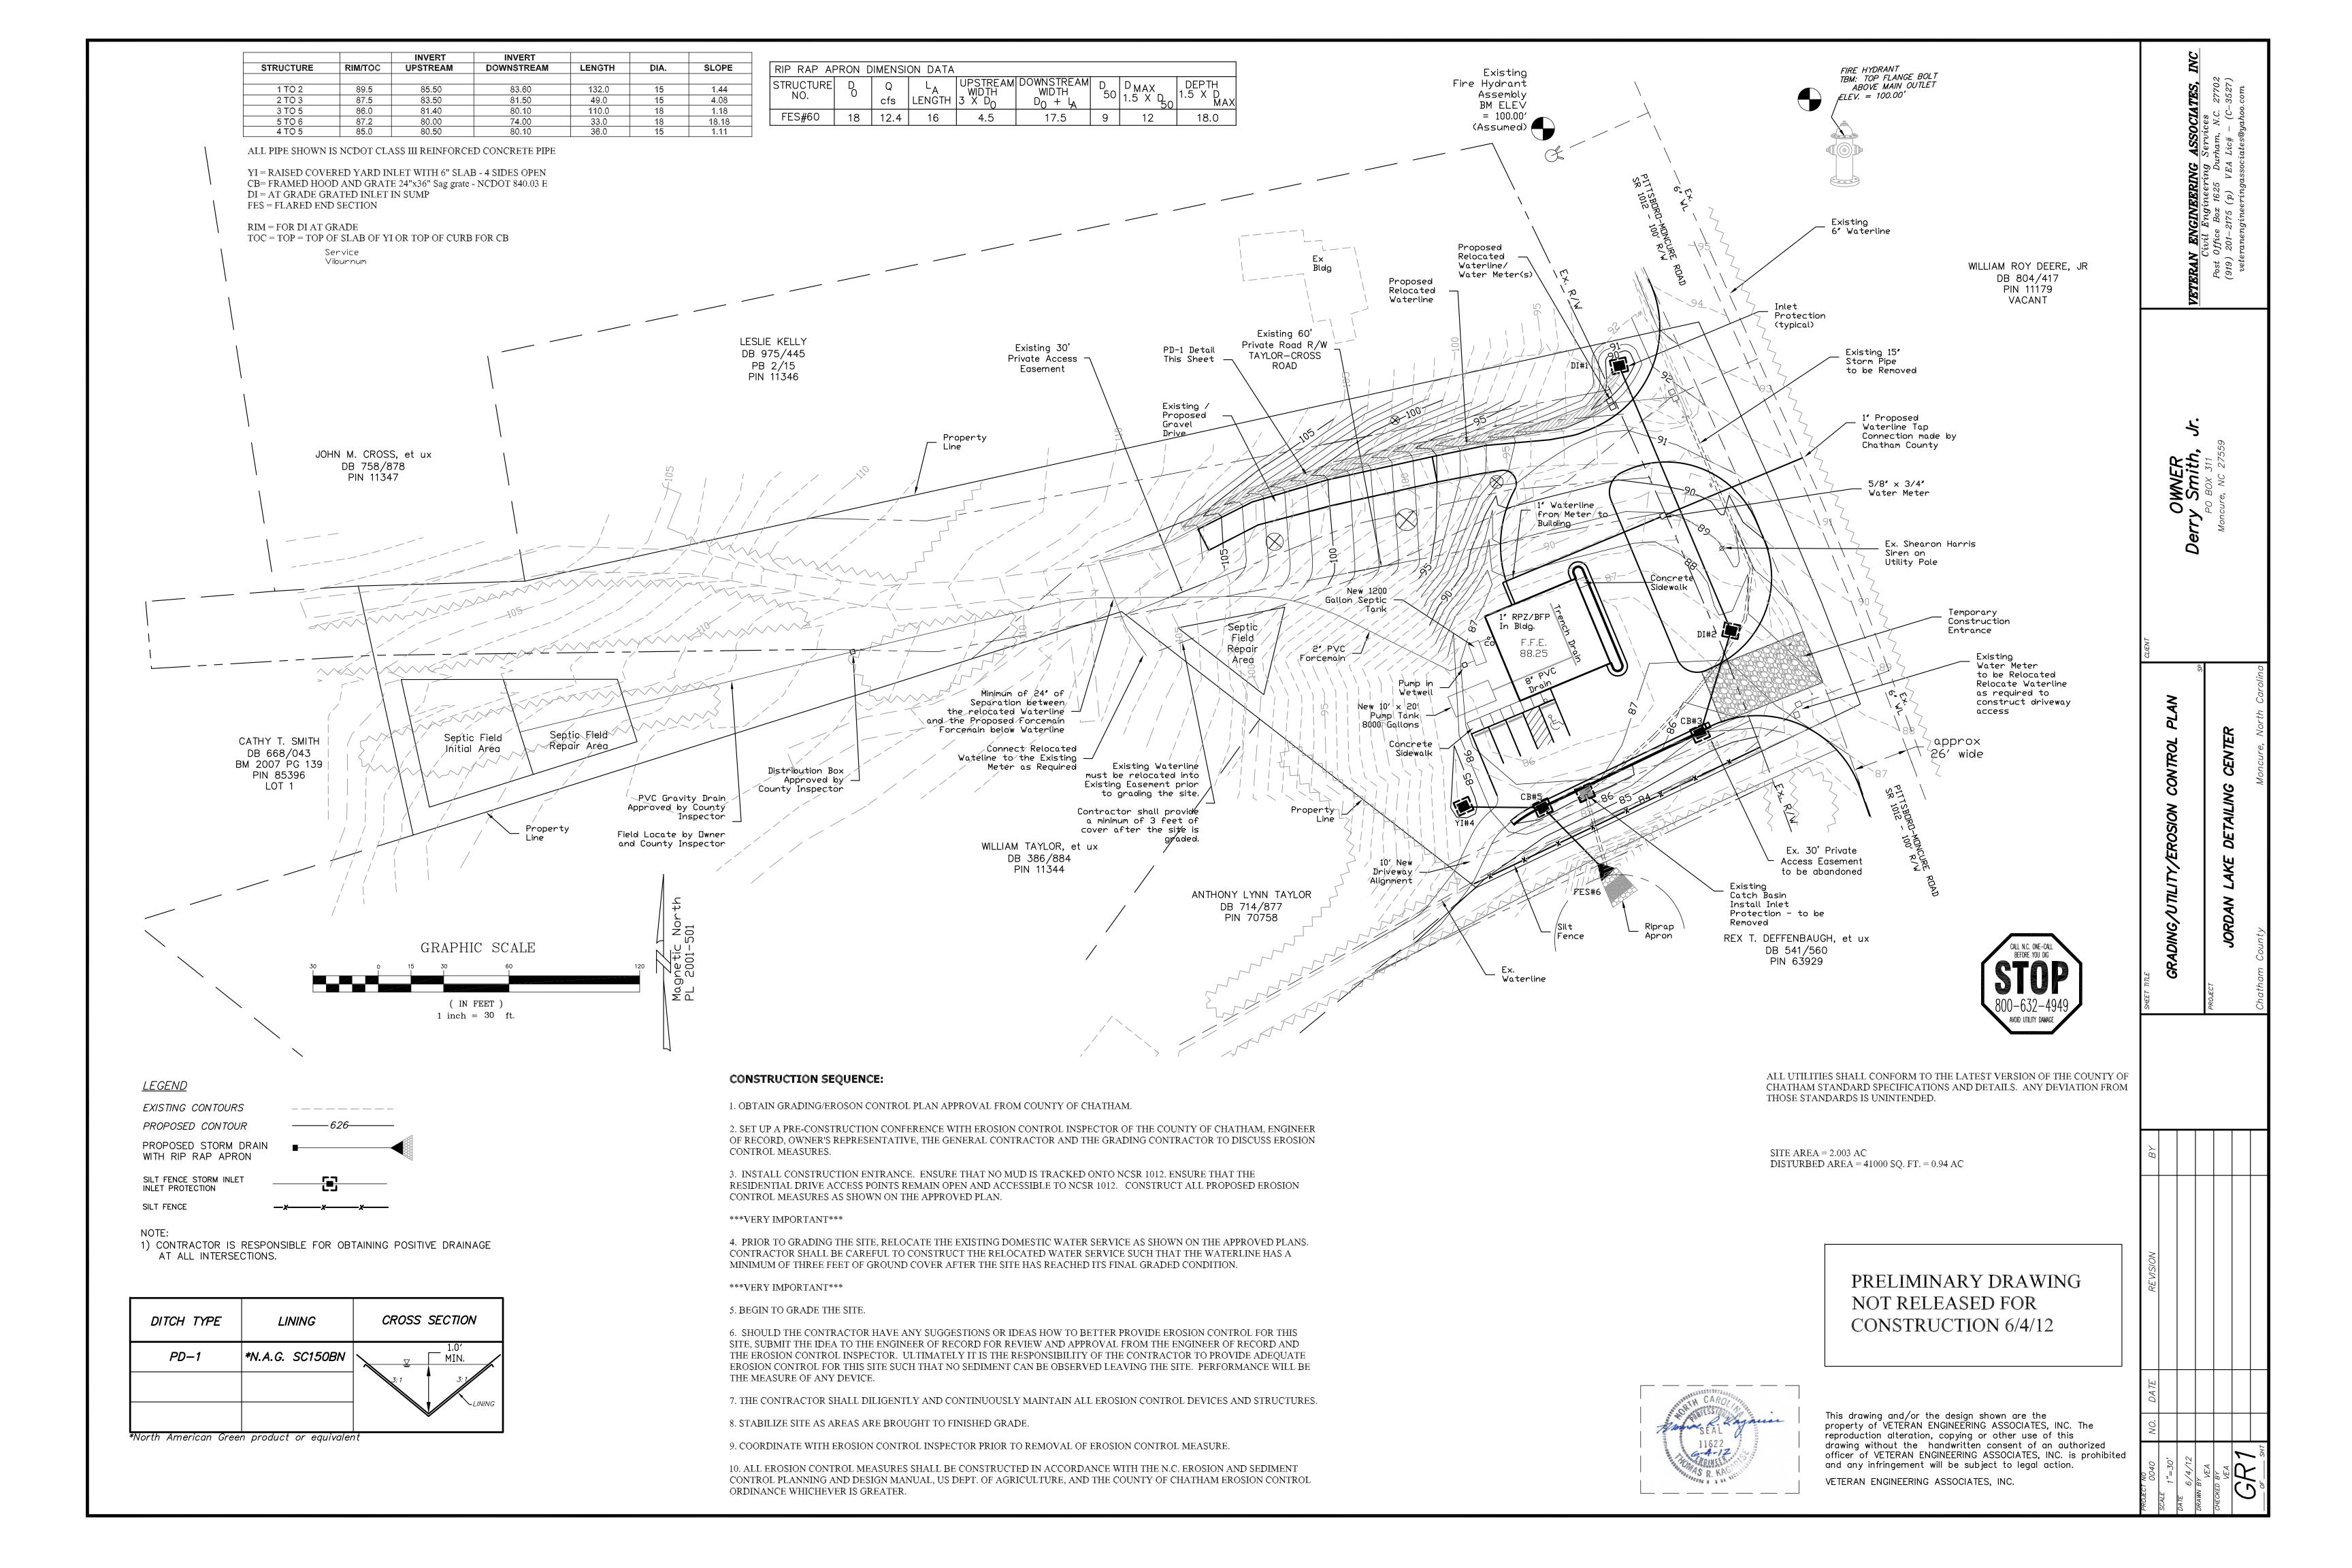CONSTRUCTED WITH TOOLED

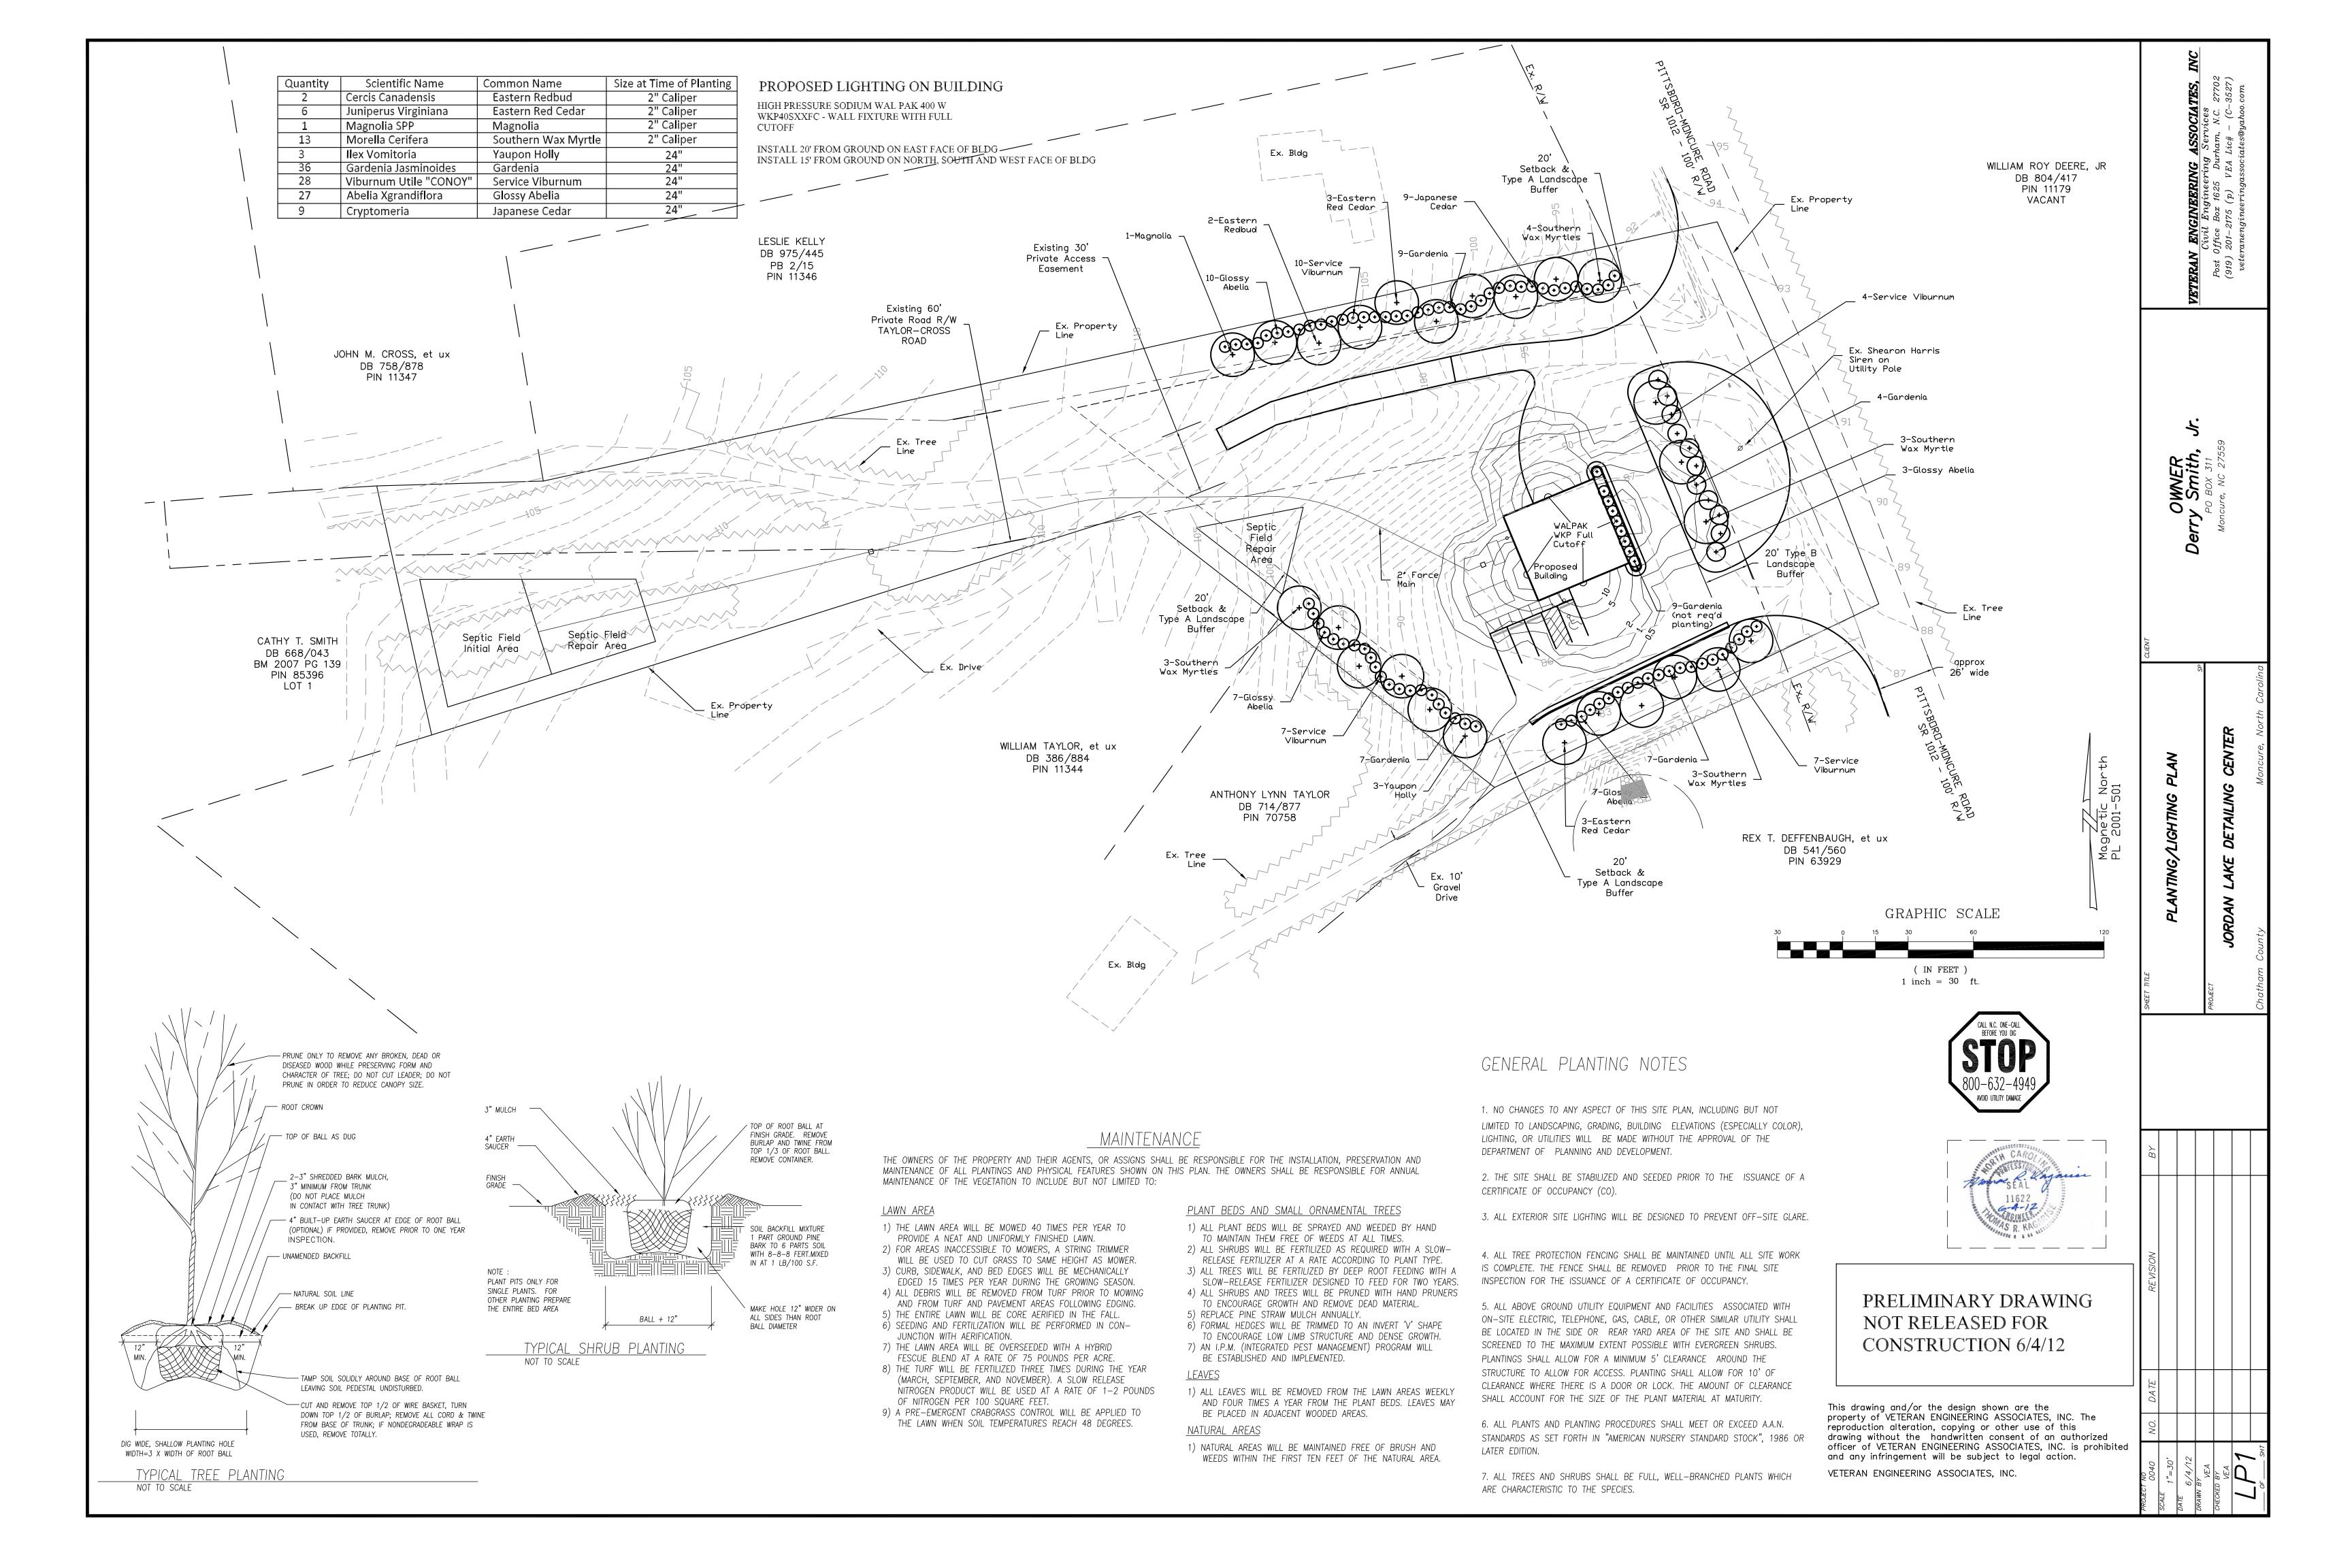
CONCRETE SIDEWALKNTS

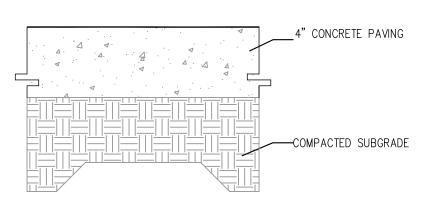

PARKING PAVEMENT SCHEDULE

(TO BE VERIFIED BY OWNERS GEOTECHNICAL ENGINEER BASED ON SITE CONDITIONS)

TYPICAL PAVEMENT SECTION NTS

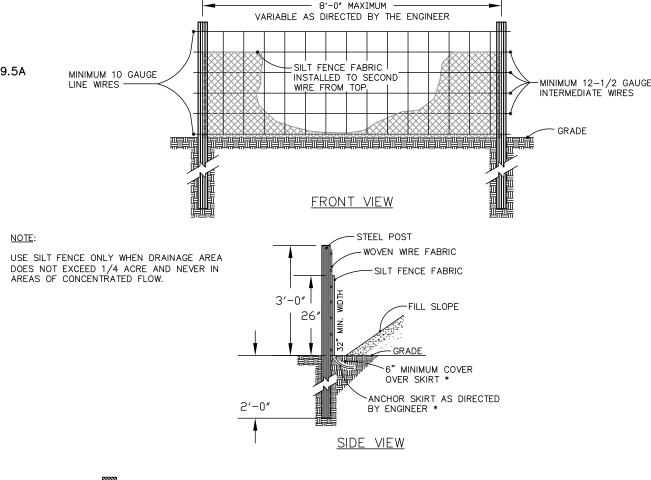

STANDARD TEMPORARY SILT FENCE


43" MINIMUM

CONCRETE SLAB

STANDARD STEPS


MAY BE CAST IN SLAB OR SECURED TO TOP OVER STEPS


STANDARD YARD INLET WITH CONCRETE SLAB

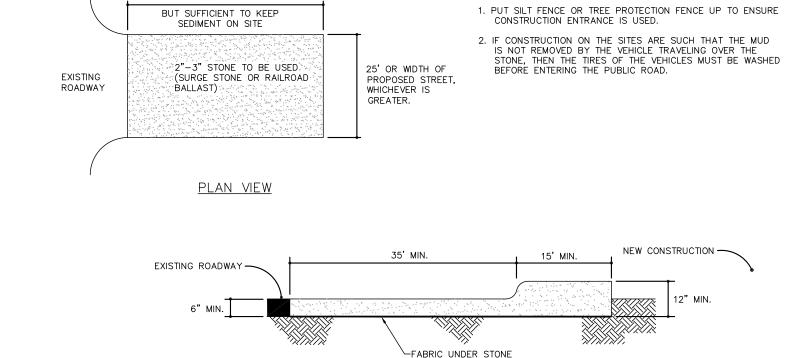

STANDARD CONSTRUCTION ENTRANCE


CROSS SECTION

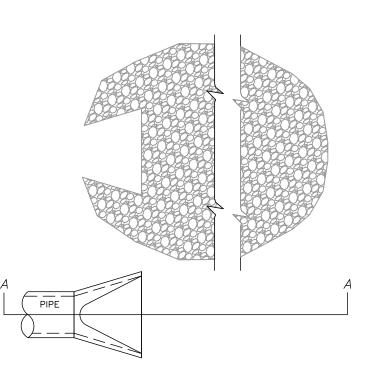

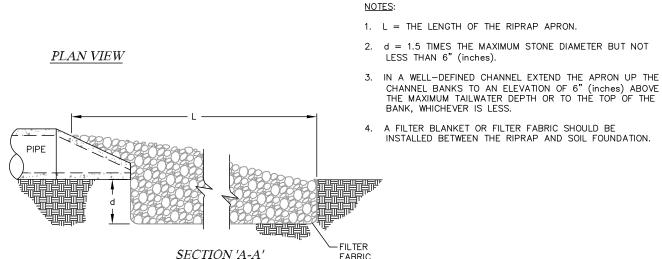

FES #6
PIPE OUTLET TO WELL-DEFINED CHANNEL

R7-8e 12"x6" RESERVED PARKING MUTCD R7-8a 12"x18" MAXIMUM PENALTY \$ 250 R7-8D 12"x9"

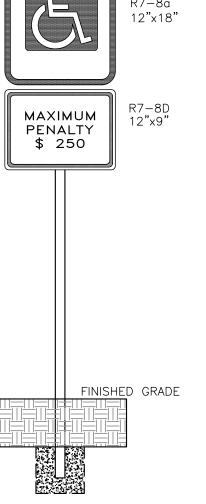

HANDICAP PARKING SIGNAGE

SEEDBED PREPARATION NOTES:

PROPOSED SIGN LOCATION
NTS

1. Surface water control measures to be installed according to

Areas to be seeded shall be ripped and spread with available topsoil 3" deep.
 Loose rocks, roots and other obstructions shall be removed from the surface so that they will not interfere with establishment and maintenance of vegetation. Surface for

reasonably smooth and uniform.

4. If no soil test is taken, fertilizer and lime to be according to seeding specifications above. In addition, provide

final seedbed preparation, at finish grades shown, shall be

- 15 lbs./1000 s.f. of superphosphate.
 5. If soil test is taken, provide fertilizer and lime according to soil test report.
- 6. Fertilizer and lime shall be applied uniformly and mixed with the soil during seedbed preparation.
- 7. Additional erosion control measures may be required depending on field conditions.
- 8. Mulch to be tacked or mechanically tied down within two days after mulch is spread.
- 9. Buffer zones to be used only as specifically denoted on plans. 10. Borrow and fill to be balanced on site.

GRADED SLOPES AND FILLS - The angle for graded slopes and fills shall be no greater than the angle which can be retained by vegetative cover or other adequate erosion control devices or structures. In any event, slopes left exposed shall, within 15 working days of completion of any phase of grading, be planted or otherwise provided with ground cover, devices, or structures sufficient to restrain erosion.

on more than one acre, it must be planted or otherwise stabilized within 15 working days on that portion of the tract upon which further active construction is not being undertaken, provided that this subsection shall not apply to cleared land forming the basin of a reservoir later to be inundated.

SEEDING SPECIFICATIONS:

JORDAN LAKE

DETAILING CENTER

RAISED LETTERS ATTACHED TO

BUILDING - ILLUMINATED BY WALPAK

Date Aug. 15 - Nov. 1 Nov. 1 - Mar. 1	Type Tall Fescue Tall fescue and	Planting Rate 300 lb./ac. or 7 lb./1000 s.f. 300 lb./ac. or 7 lb./1000 s.f.
Mar. 1 - Apr. 15 Apr. 15 - Jul. 30	Tall Fescue Mulled Common	300 lb./ac. or 7 lb./1000 s.f. 30 lb./ac. or 1 lb./1000 s.f.
Jul. 15 - Aug. 15	Tall Fescue and	300 lb./ac. or 7 lb./1000 s.f.

WKP WAL PAK 400 W


FULL CUT OFF

Mulch with straw applied at the rate of 75-100 lb./1000 s.f. Heavily mulched during January - March period.

Sorghum Sudan Hybrids 30 lb./ac. or 3/4 lb./1000 s.f.

Apply agricultural lime at the rate of 90 lb./1000 s.f.
Apply 10-10-10 commercial fertilizer at the rate of 20 lb./1000 s.f.
Tack: Asphalt tie down - 225 gal./ac.

GRADED SLOPES AND FILLS - Cut and Fill slopes that are (2:1) or greatere shall be stabillized with permanent slope retention devices or a suitable combination of plantings and retention devices. Slopes greatere than three to one (3:1) shall not be stabilized with turf grass but must be stabillized with vegetation that requires minimal maintenance. Weeping Love Grass, Red Fescue or other approved variety.

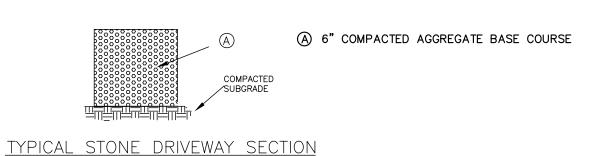

1. EITHER SOLID BRICK, SOLID BLOCK, OR PRECAST

3. USE MINIMUM 3000 P.S.I. CONCRETE MIX.

COVER TO BE LOCATED OVER STEPS.

2. STANDARD STEPS REQUIRED @ 16 INCHES O.C. WHERE

 4. INSIDE DIMENSION FOR 24 INCH PIPE AND GREATER USE PIPE DIAMETER PLUS 12 INCHES.
 5. WHERE DEPTH EXCEEDS 3 FEET, MANHOLE RING AND

CONCRETE MAY BE USED.

CONCRETE SLAB DESIGNED

(TO BE VERIFIED BY OWNERS GEOTECHNICAL ENGINEER BASED ON SITE CONDITIONS)

TYPICAL STONE DRIVEWAY SECTION NTS


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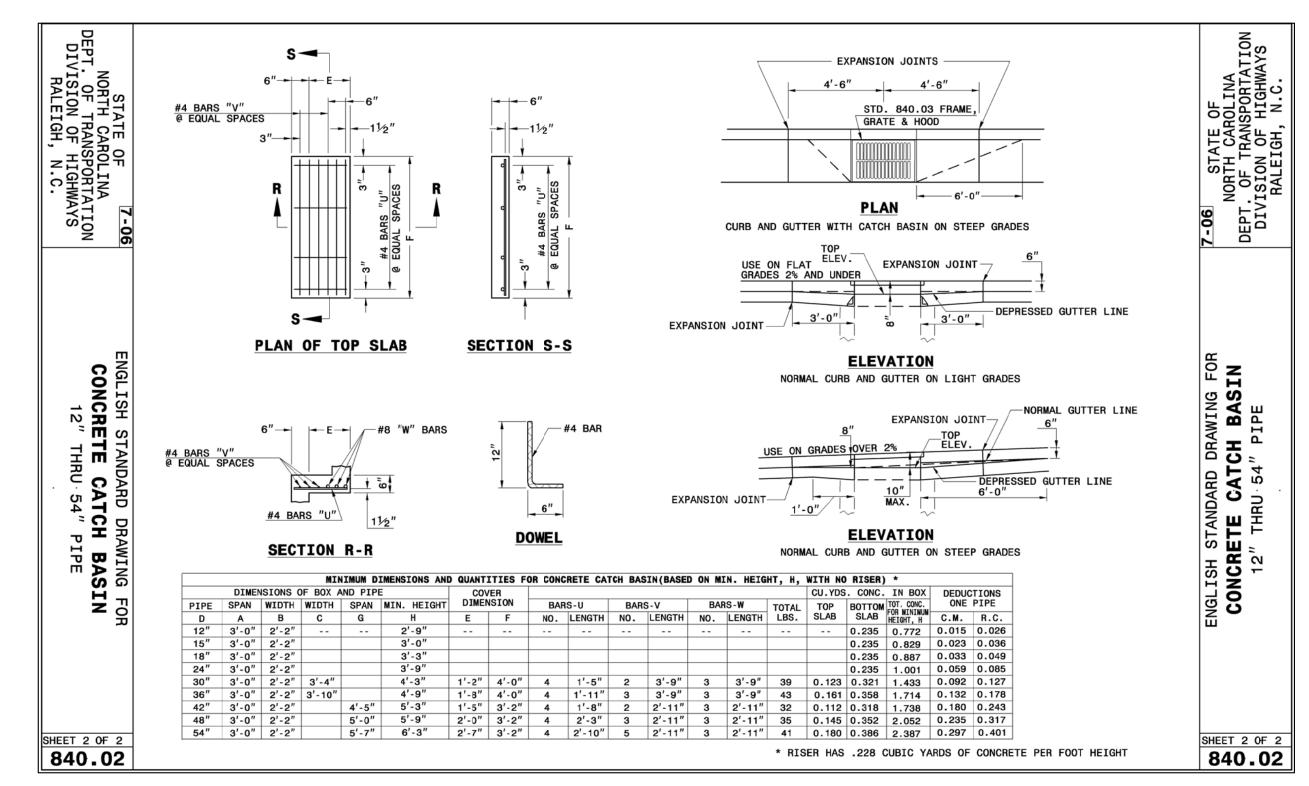
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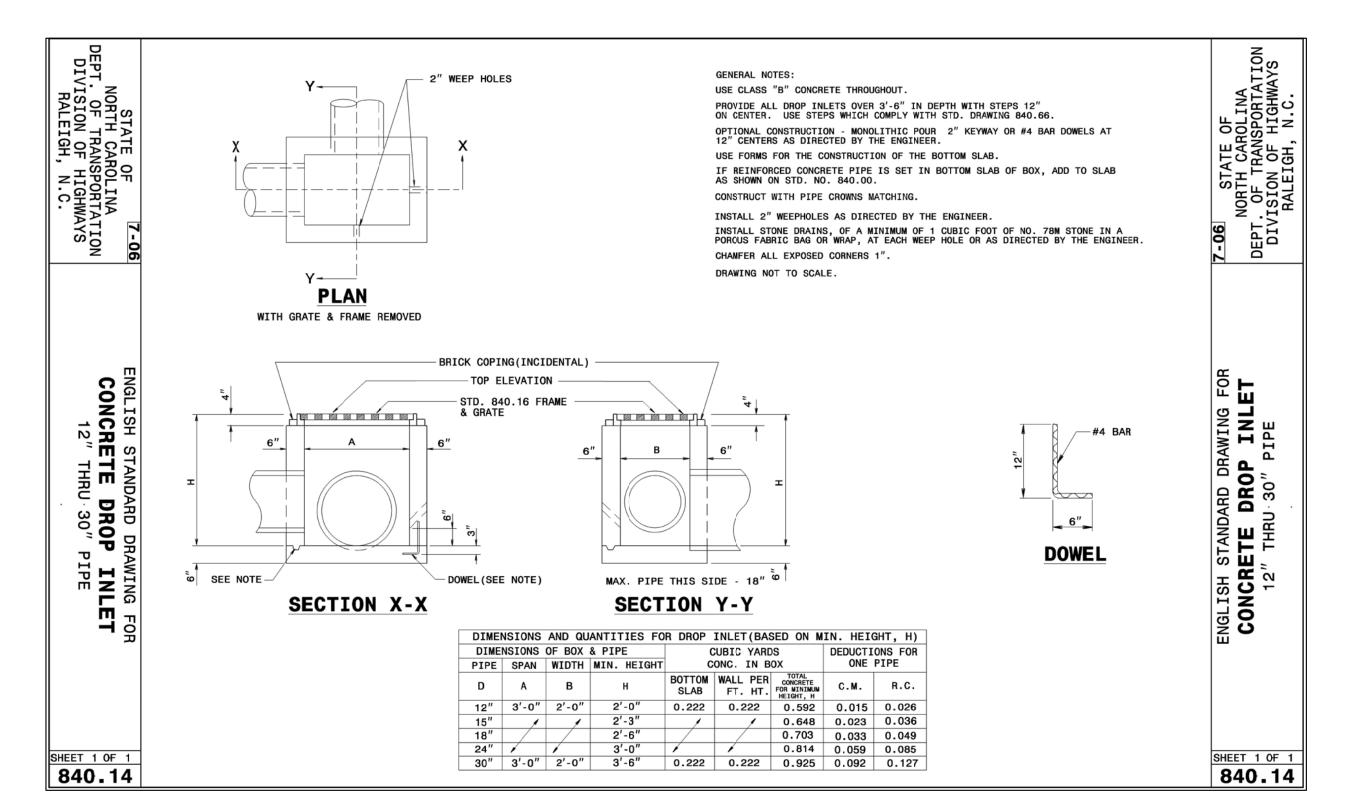
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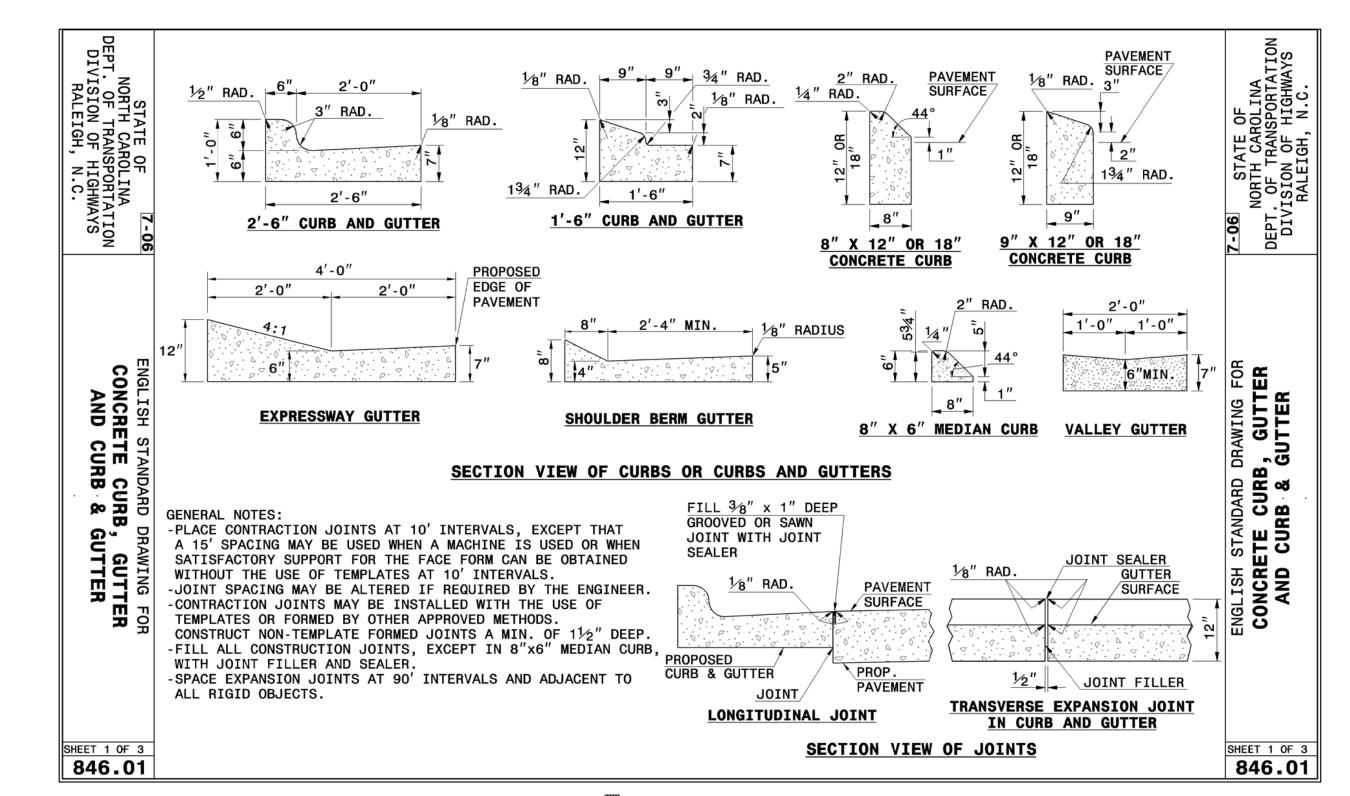




CB #3 AND #5
STANDARD CATCH BASIN
NTS



DI #1 AND #2
STANDARD DROP INLET

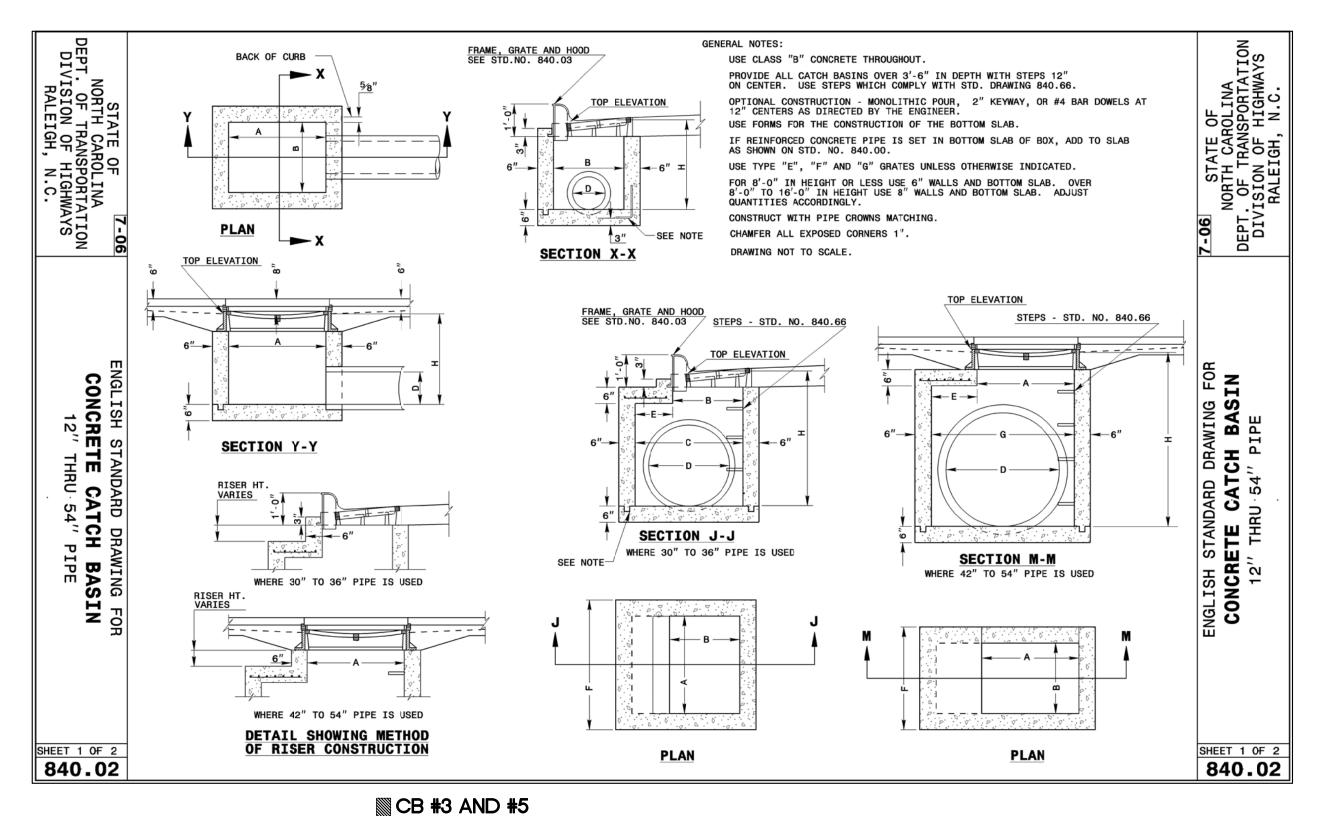

30" CURB AND GUTTER NTS


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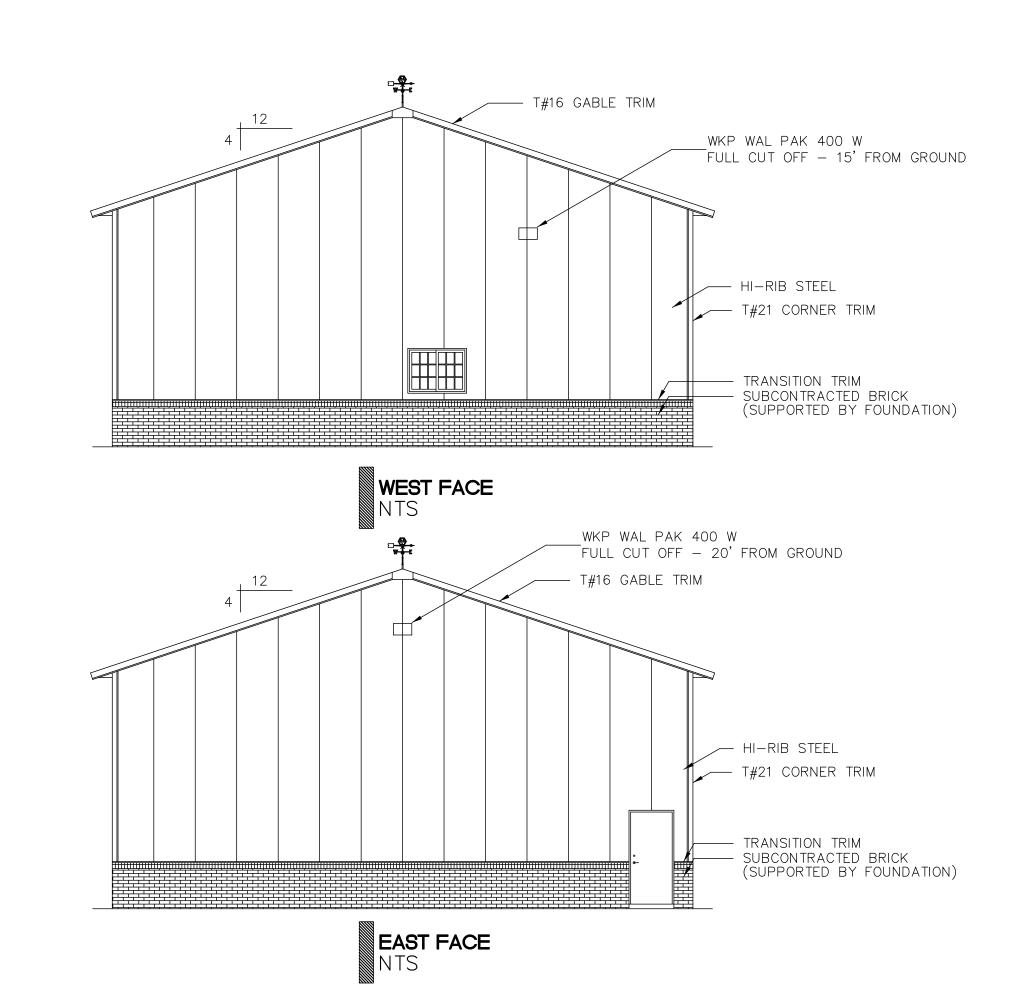



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VETERAN ENGINEERING ASSOCIATES, INC.

BY						
REVISION						
NO. DA TE						
PROJECT NO 0040	SCALE $1"=30'$	DATE 6/4/12	DRAWN BY VEA	CHECKED BY VEA	60	С С — 0F — SHT





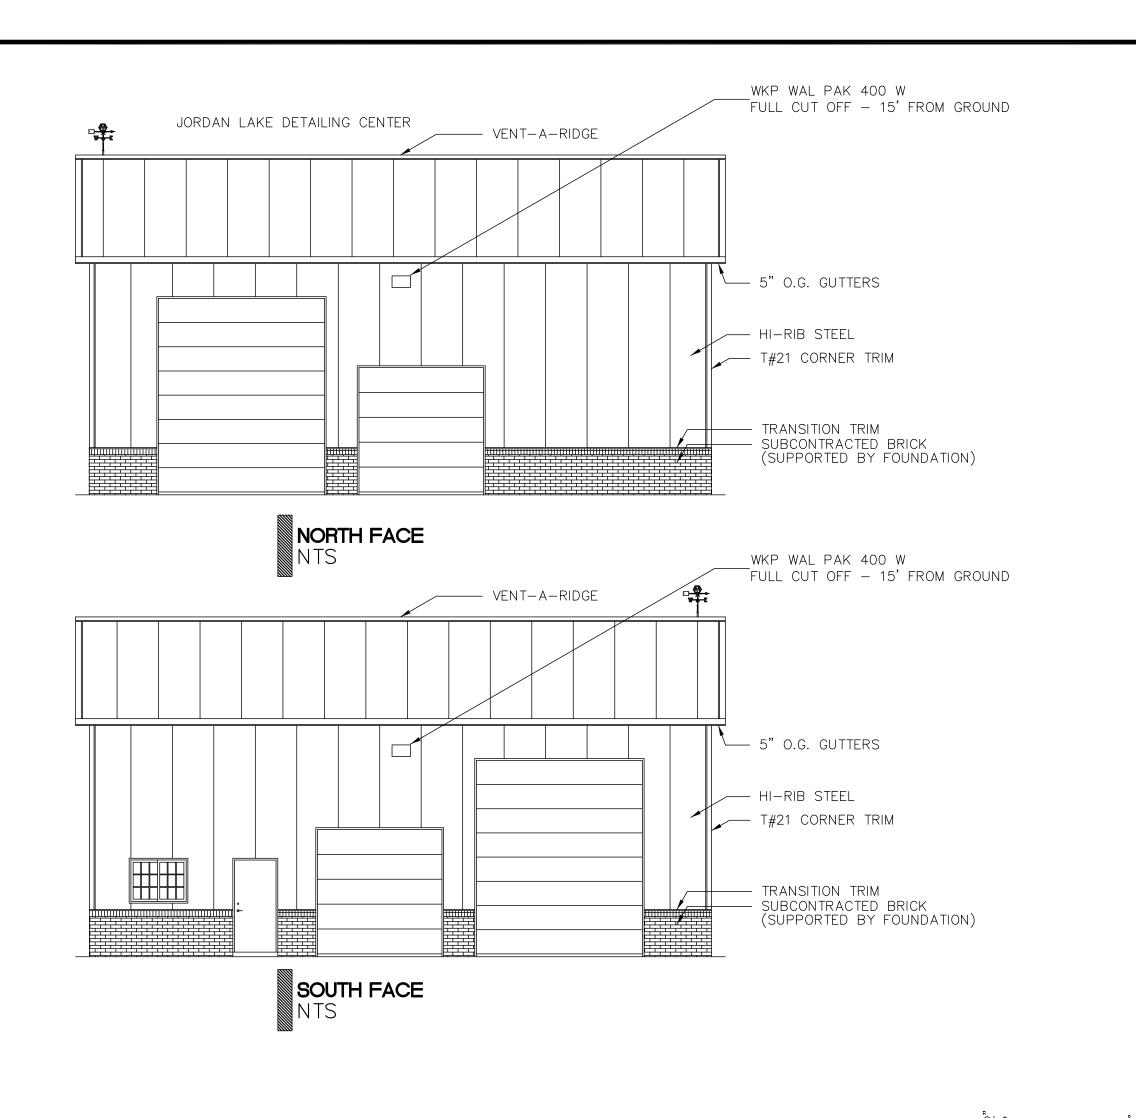
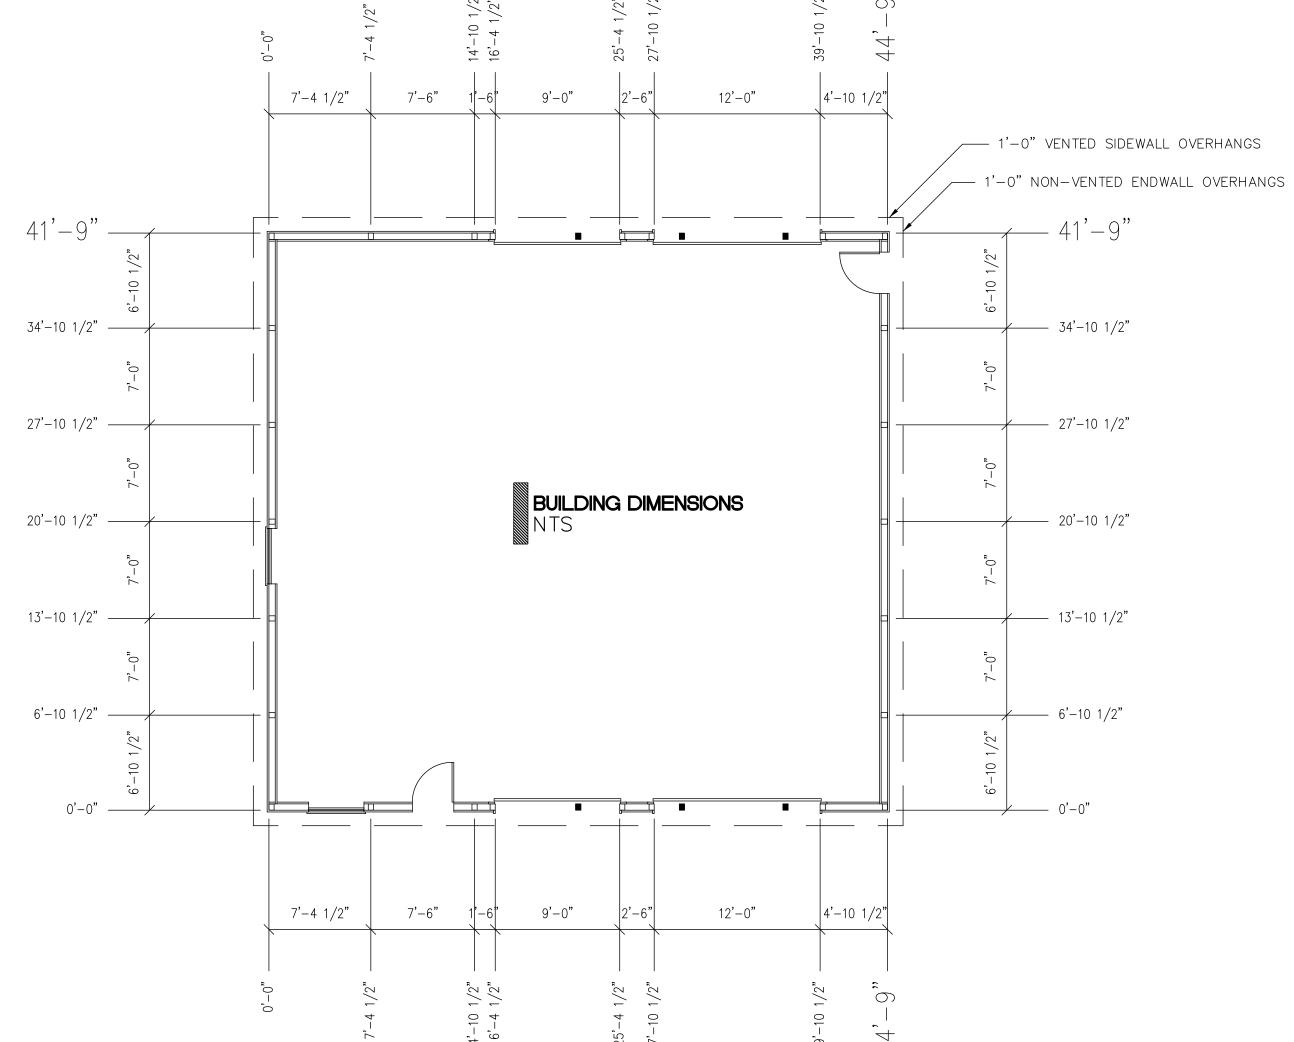
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VETERAN ENGINEERING ASSOCIATES, INC.

	OWNER Derry Smith, Jr. PO BOX 311 Moncure, NC 27559 Weteranengineeringassociates@yahoo.co							
CLIENT	DETAILS sp			AN LAKE DETAILING CENTER		Moncure, North Carolina		
SHEET 117LE	7		PROJECT	JORD.		Chatham County		
BY								
REVISION								
NO. DATE								
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